# **04 - CIVIL**INDEX OF DRAWINGS


DRAWING NUMBER	DRAWING TITLE	DRAWING NUMBER	DRAWING TITLE
C-001	INDEX OF DRAWINGS		
C-002	DEMOLITION		
C-003	SITE PLAN		
C-004	DRAINAGE PLAN		
C-005	UTILITY PLAN		
C-006	GRADING PLAN		
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C-008	MISCELLANEOUS DETAILS - 1		
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CT-001	MOTOR FUEL ISLAND PLAN		
CT-002	MOTOR FUEL TANKS DETAILS		
CT-003	MOTOR FUEL ISLAND DETAILS		


THE DESIGN APPEARS TO CONFORM TO APPLICABLE CRITERIA. APPROVAL IS NOT TO BE CONSTRUED TO MEAN THAT ALL ASPECTS OF THE DESIGN HAVE BEEN PERSONALLY CHECKED BY THE UNDERSIGNED.

TRANSPORTATION PRINCIPAL ENGINEER

					DESI
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				IN NO WAY WARRANTED TO INDICATE THE CONDITIONS OF ACTUAL QUANTITIES	
				OF WORK WHICH WILL BE REQUIRED.	
REV.	DATE	REVISION DESCRIPTION	SHEET NO.	Plotted Date: 8/12/2015	

ESIGNER/DRAFTER:  ME	
HECKED BY: <b>SK</b>	E
	]

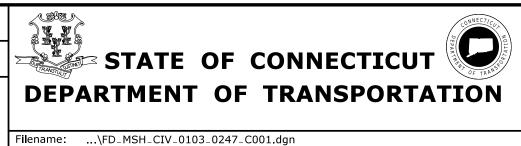

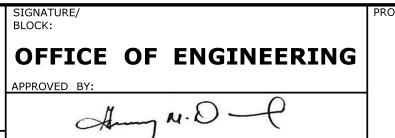



OCCUM MAINTENANCE FACILITY OCCUM


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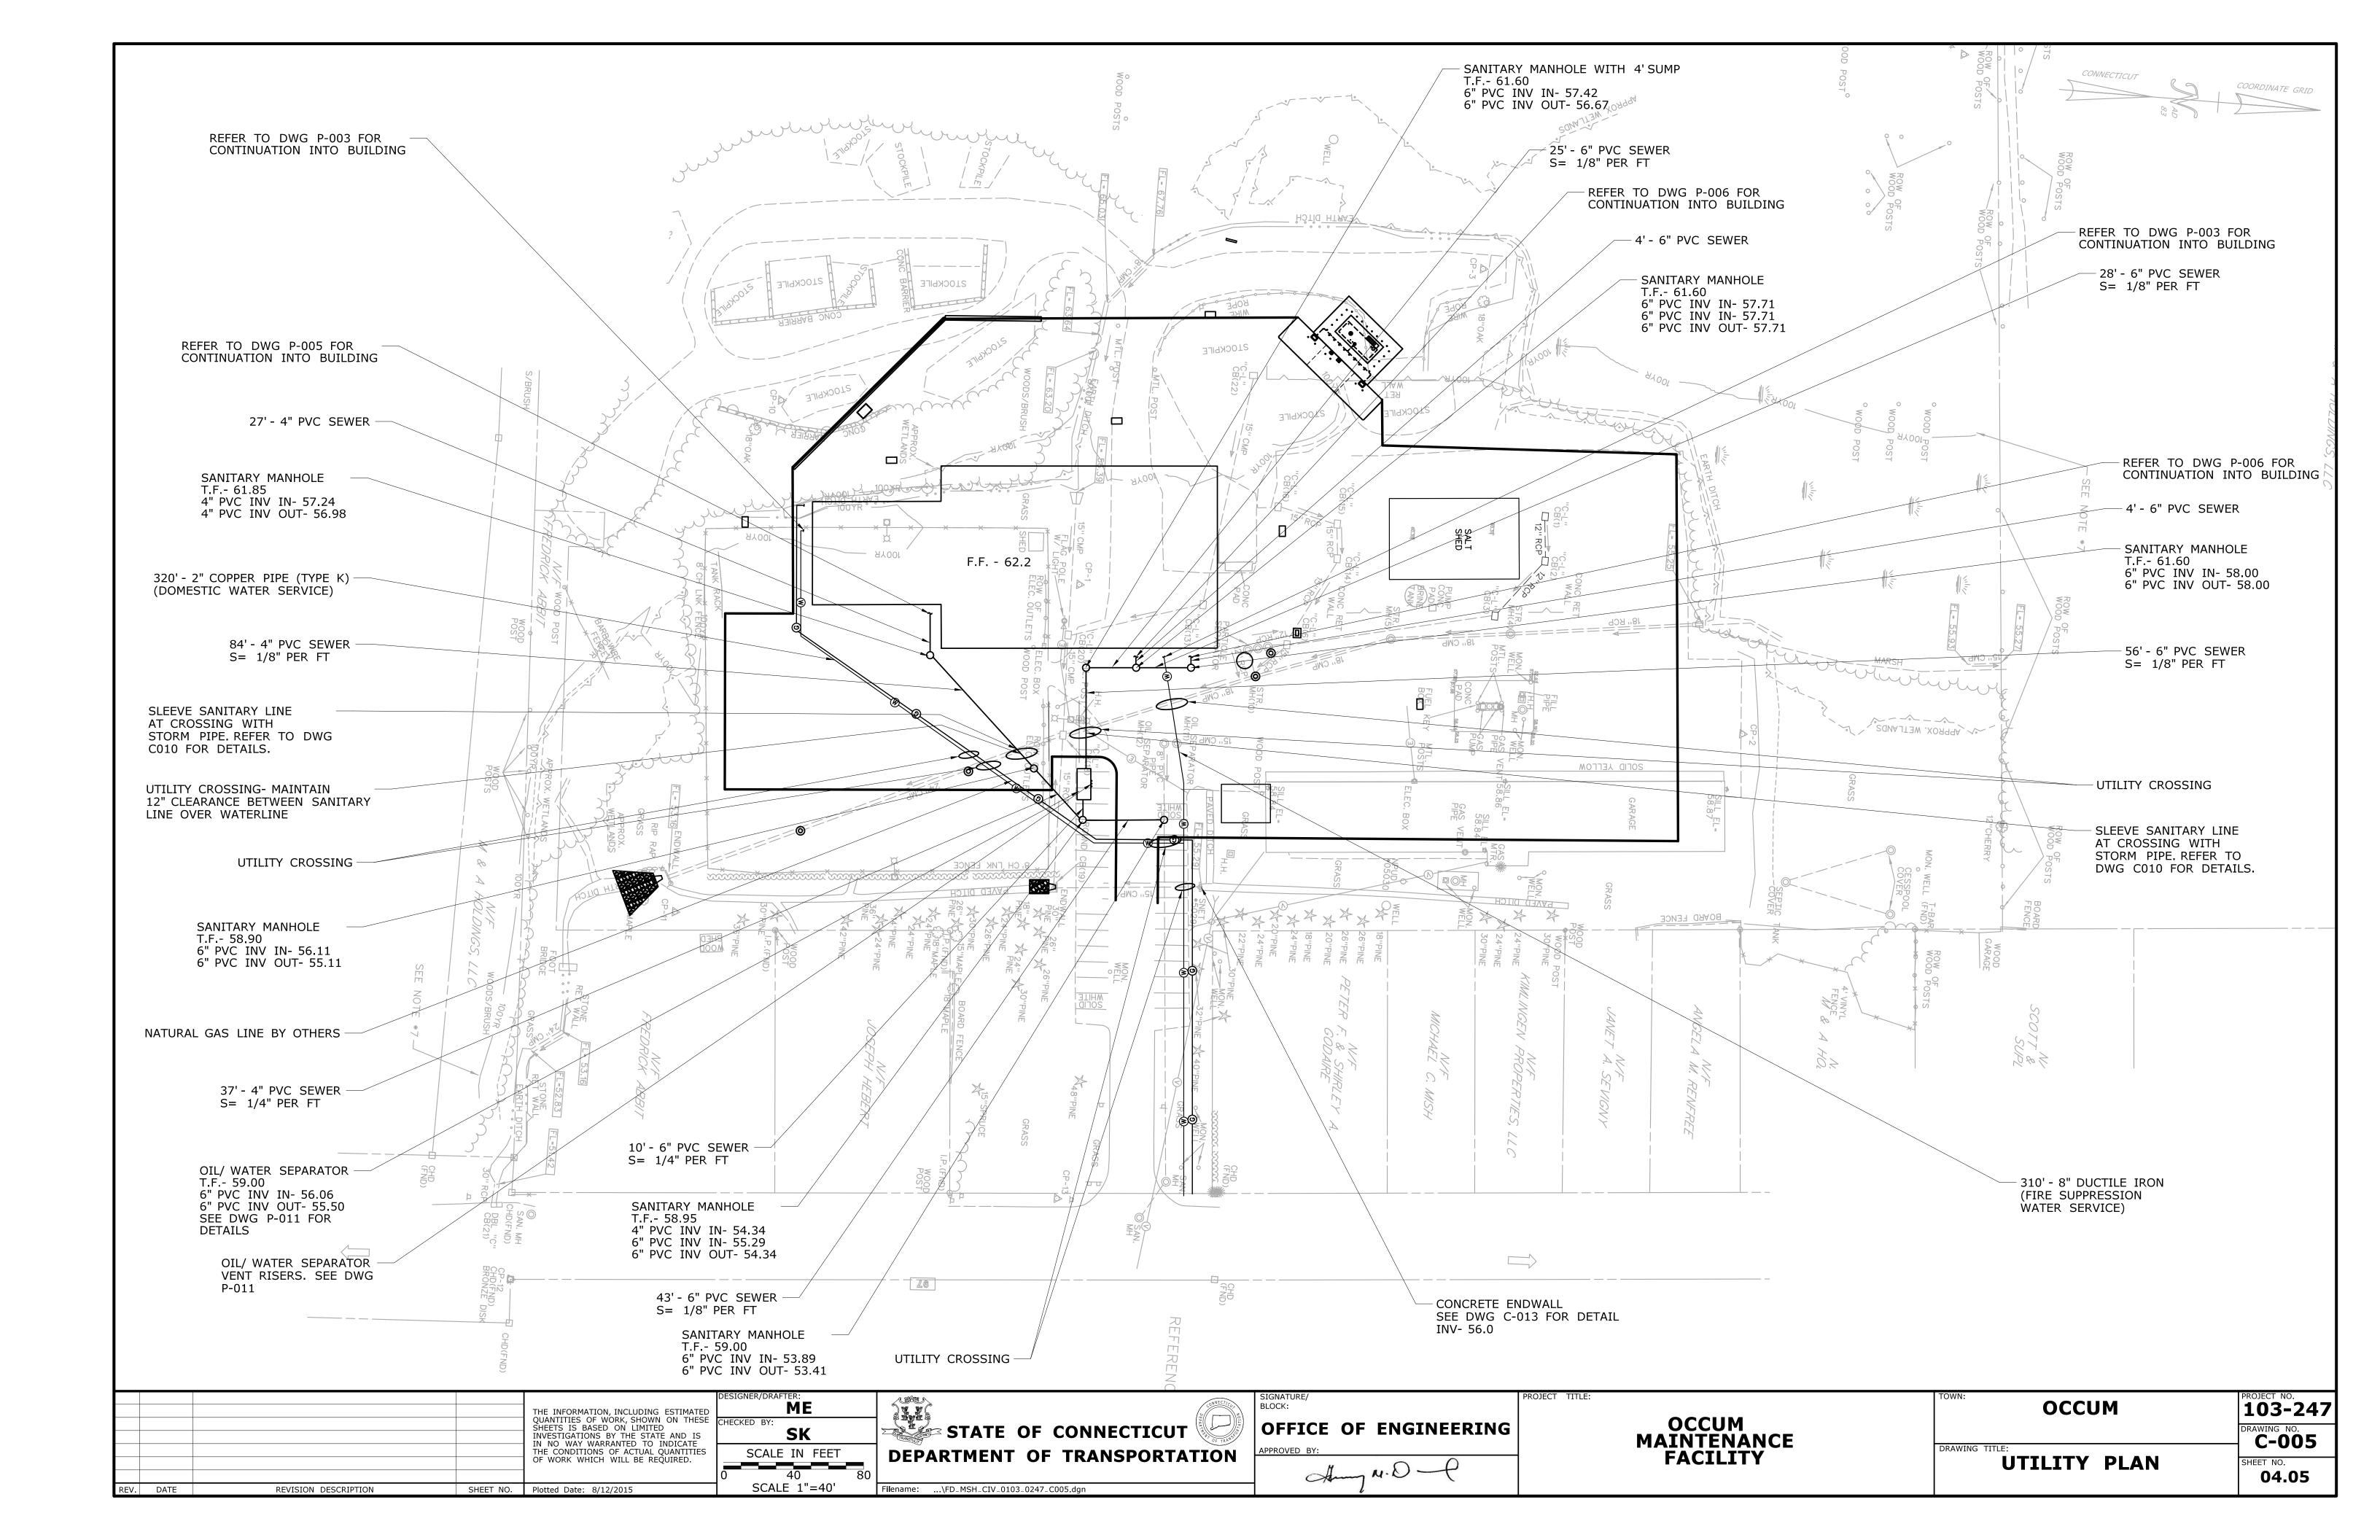
INDEX OF DRAWINGS


SHEET NO.
04.01




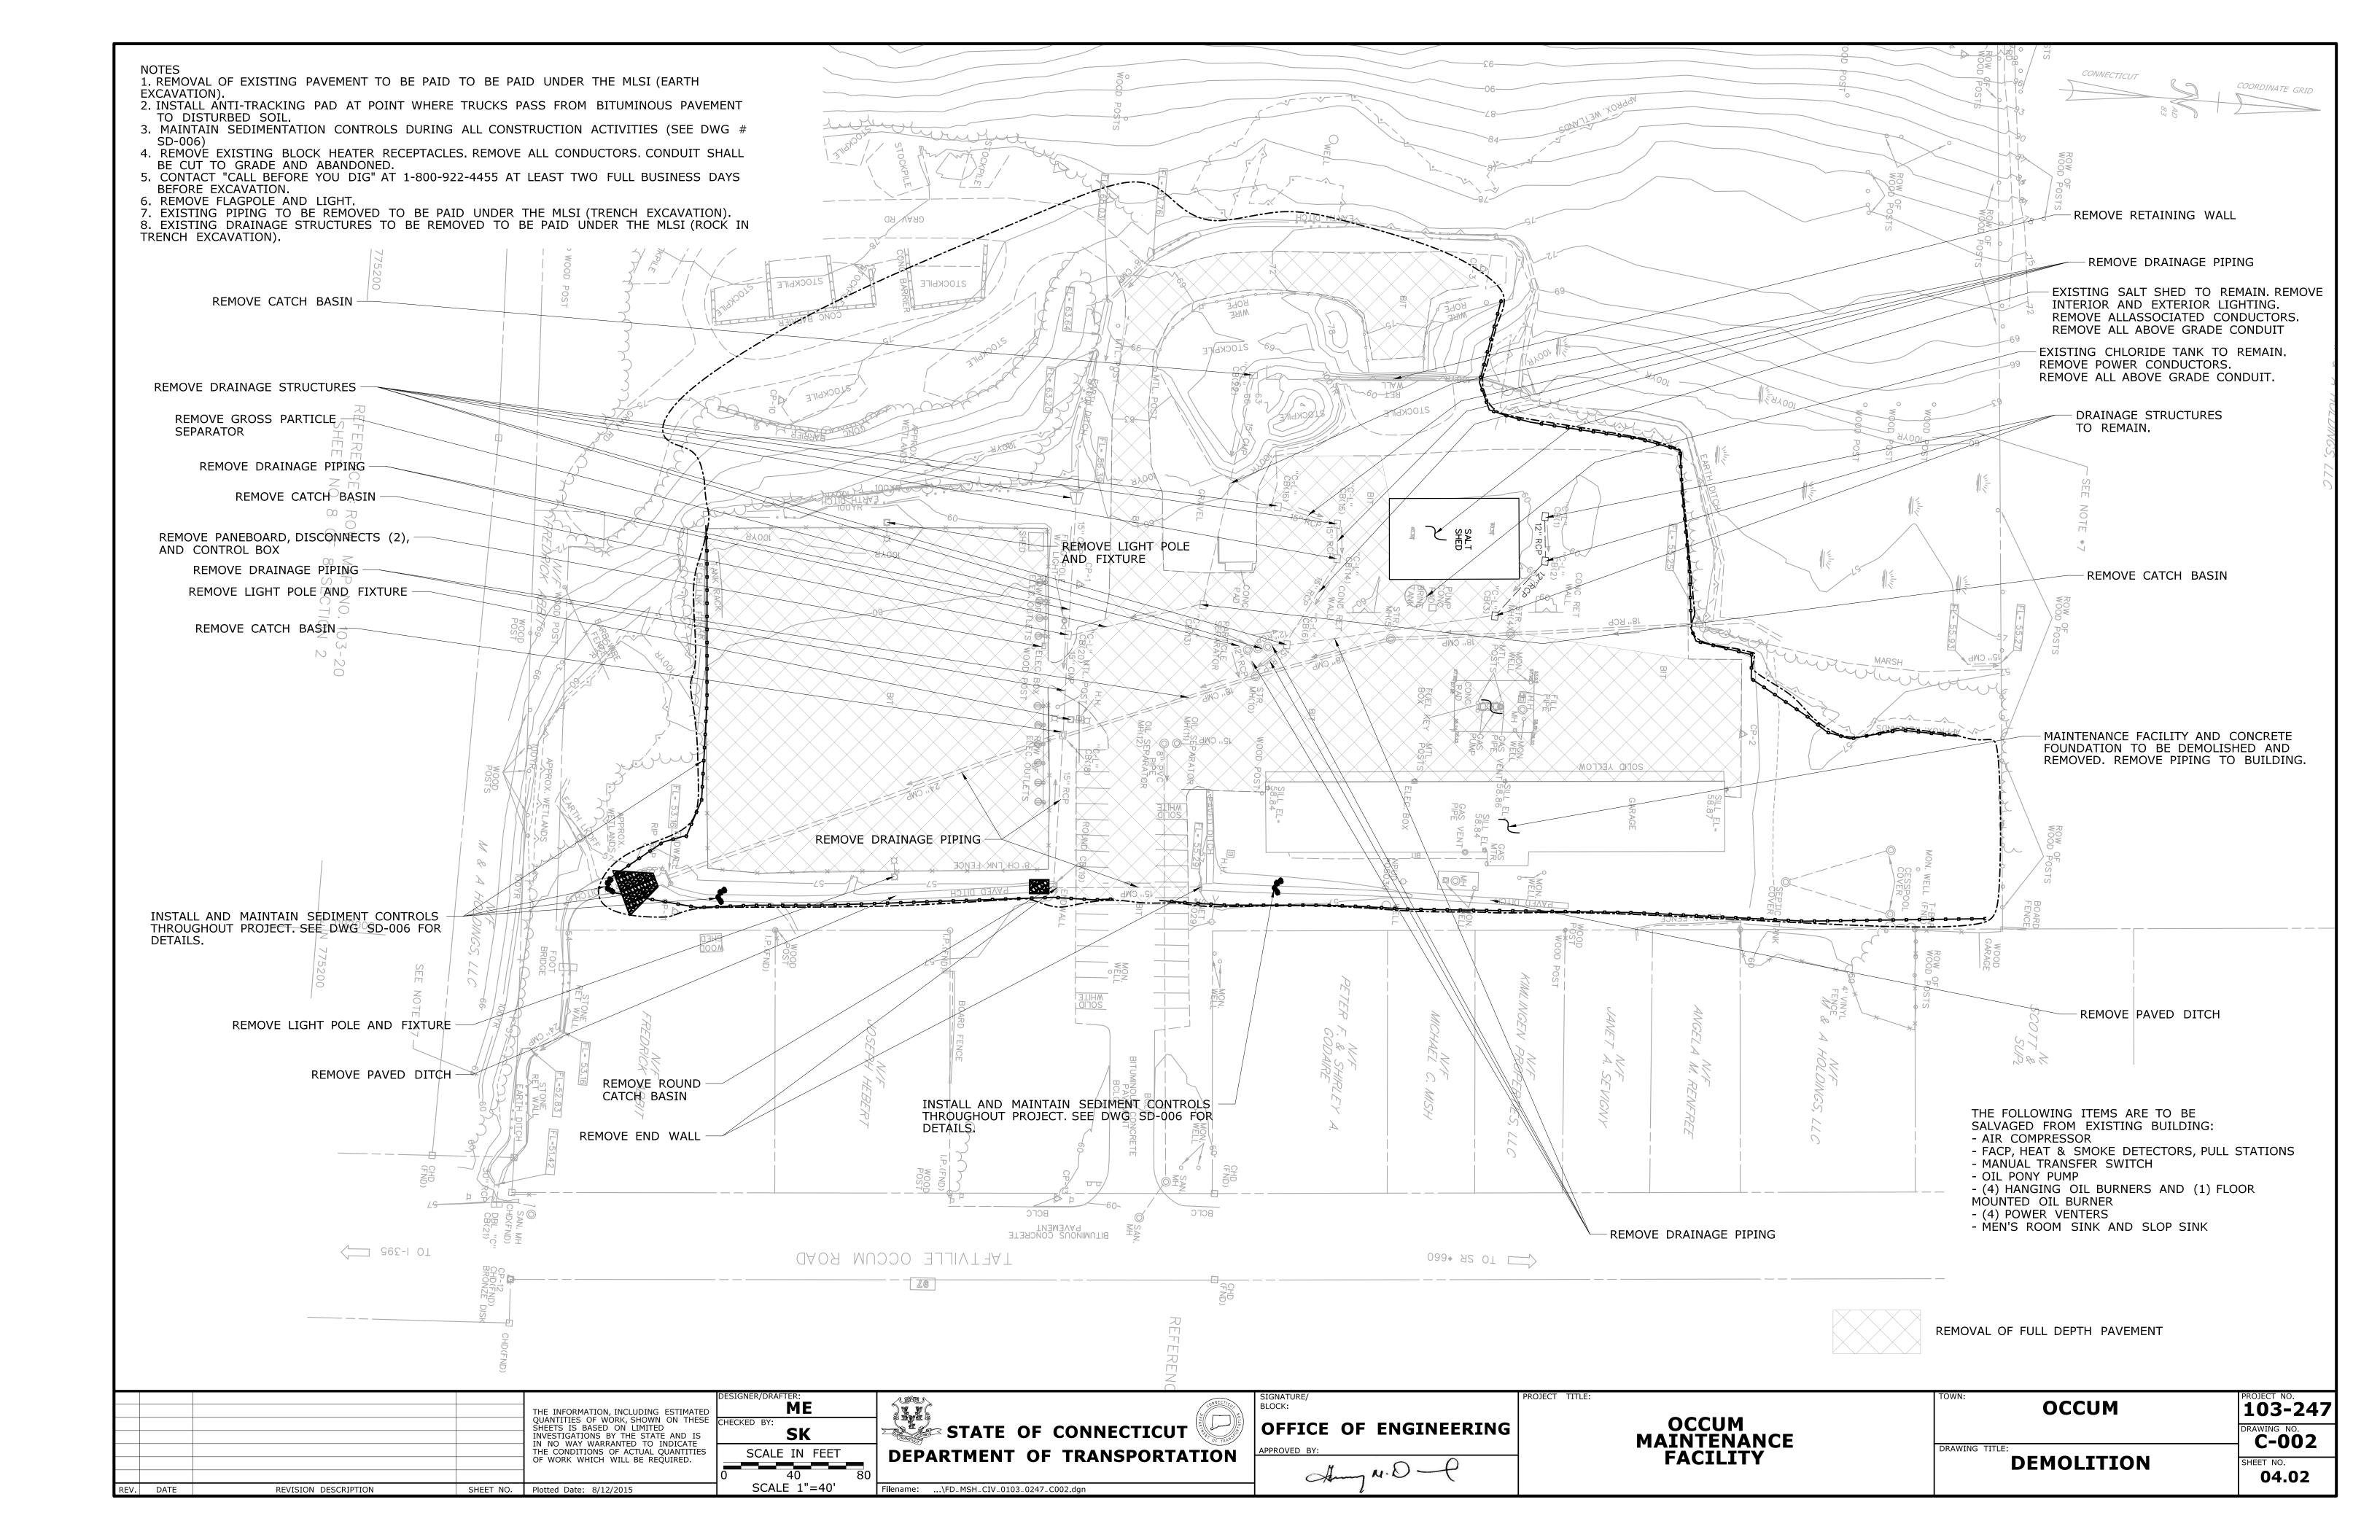


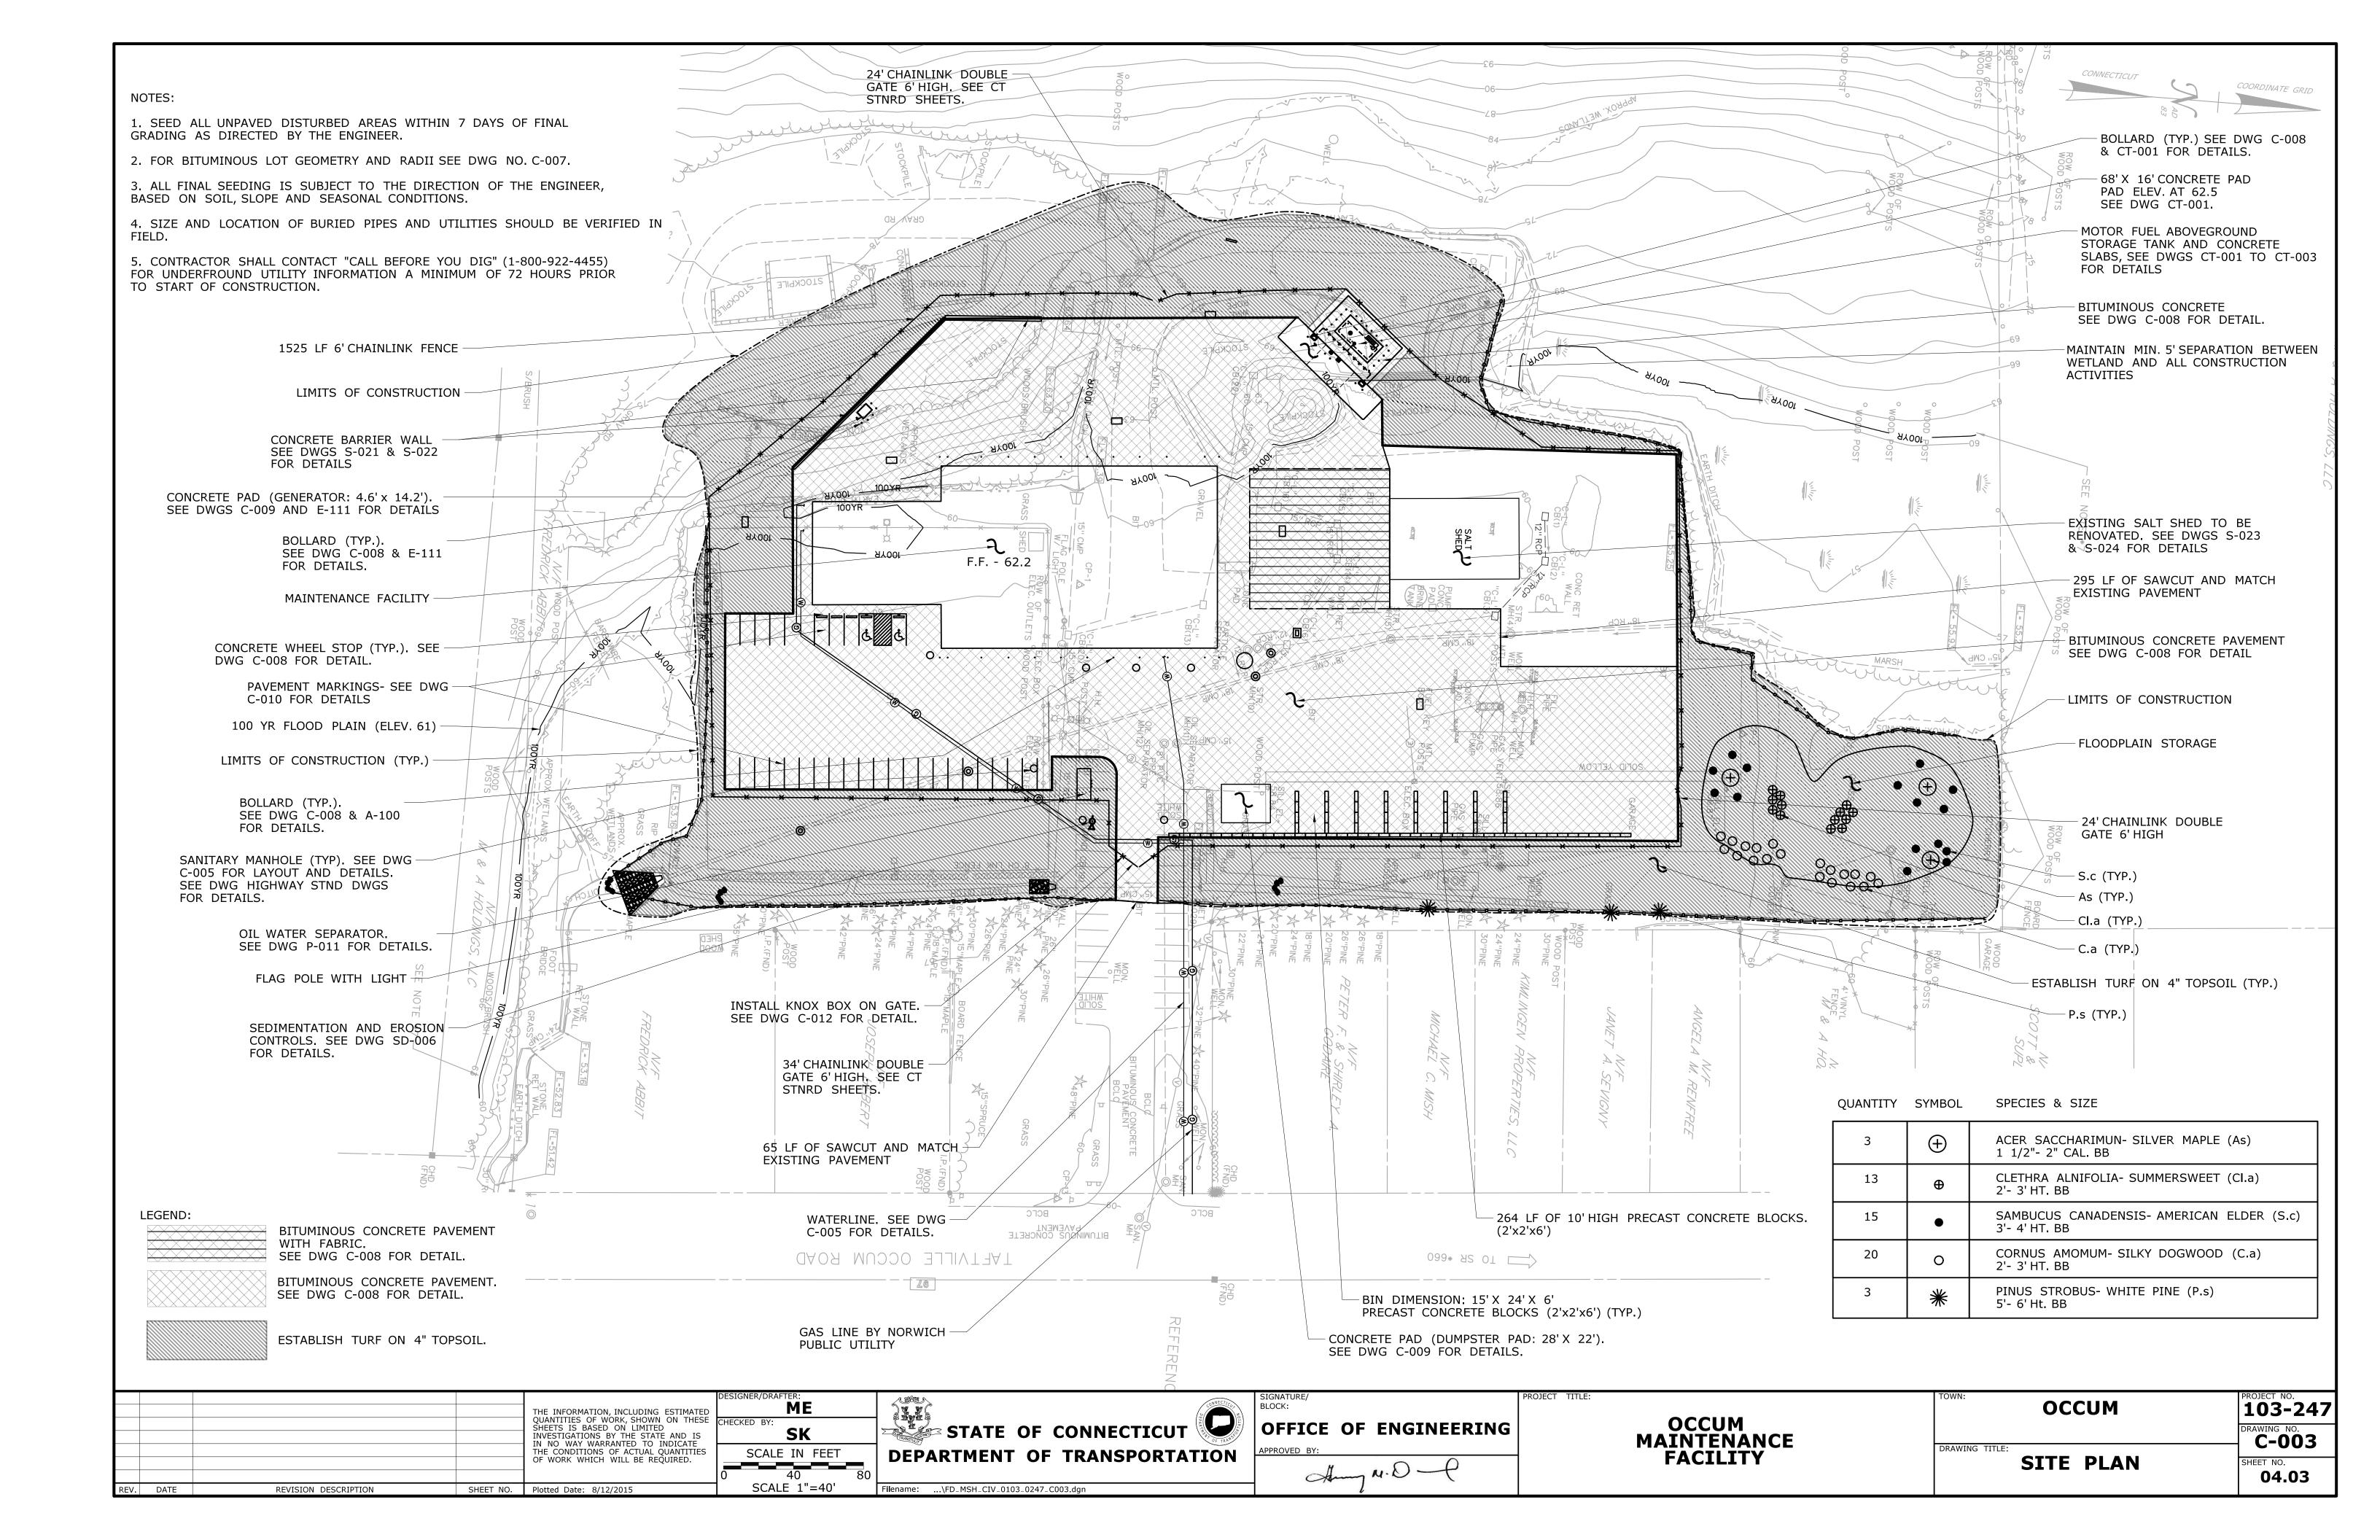

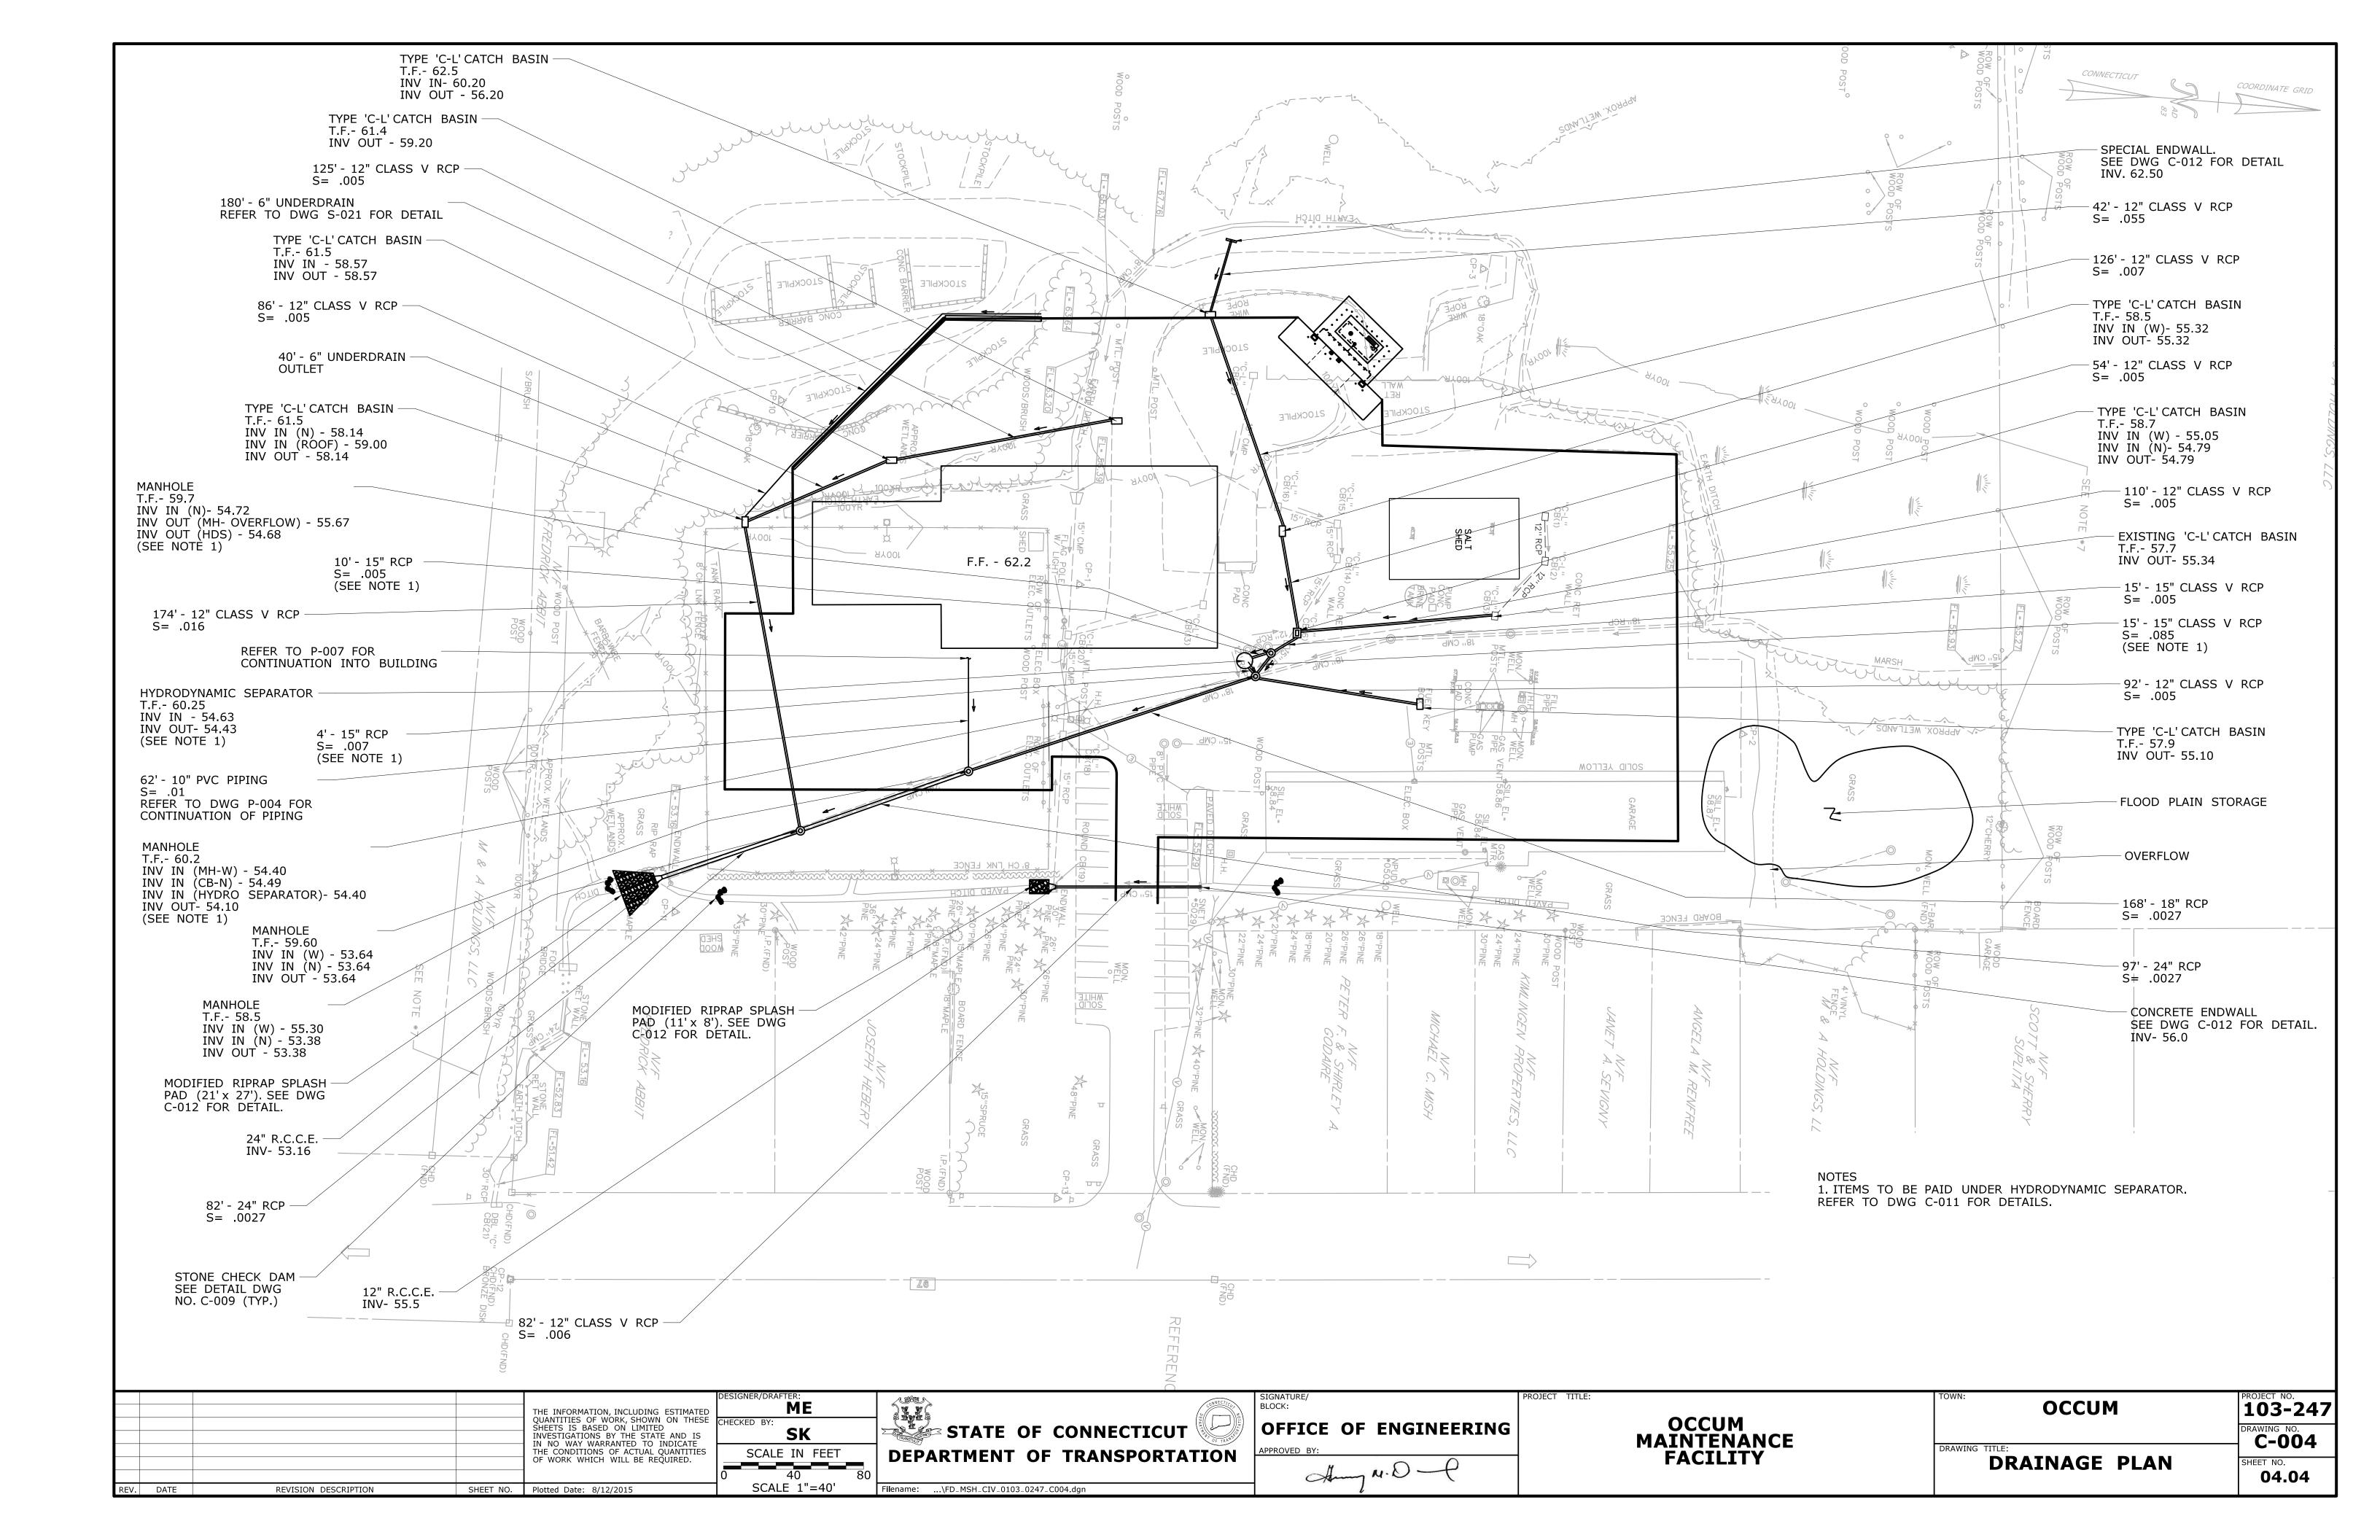

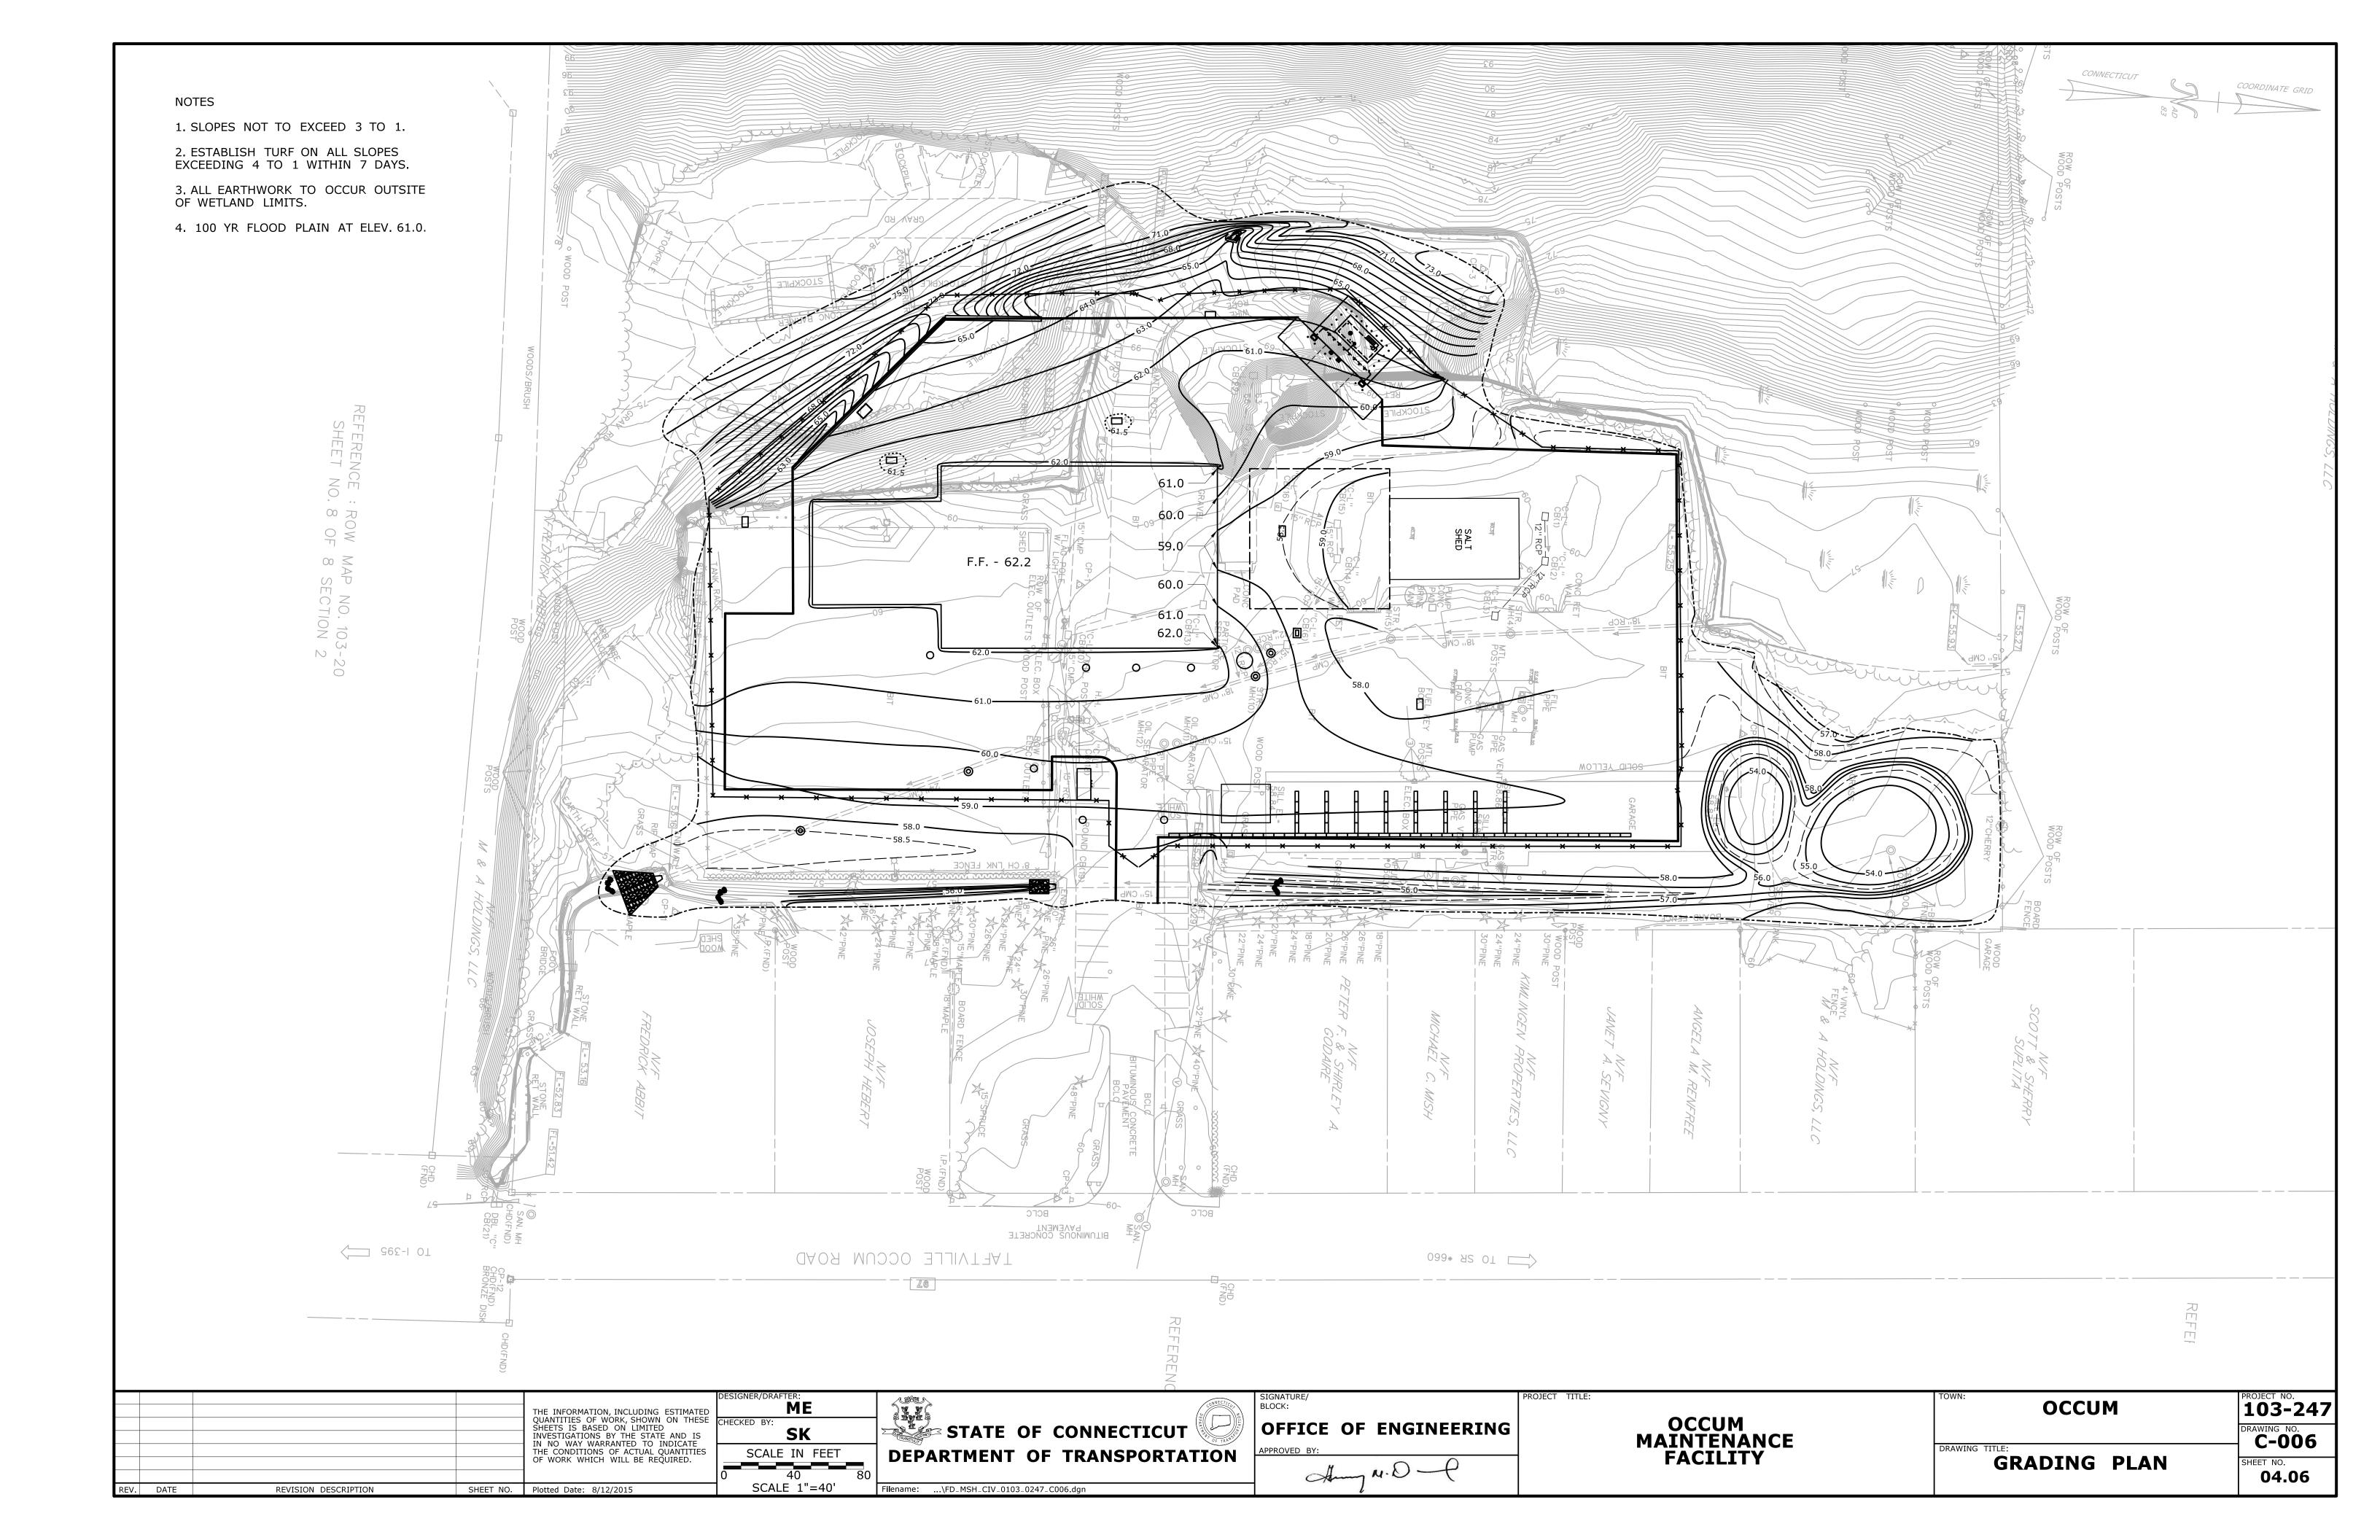

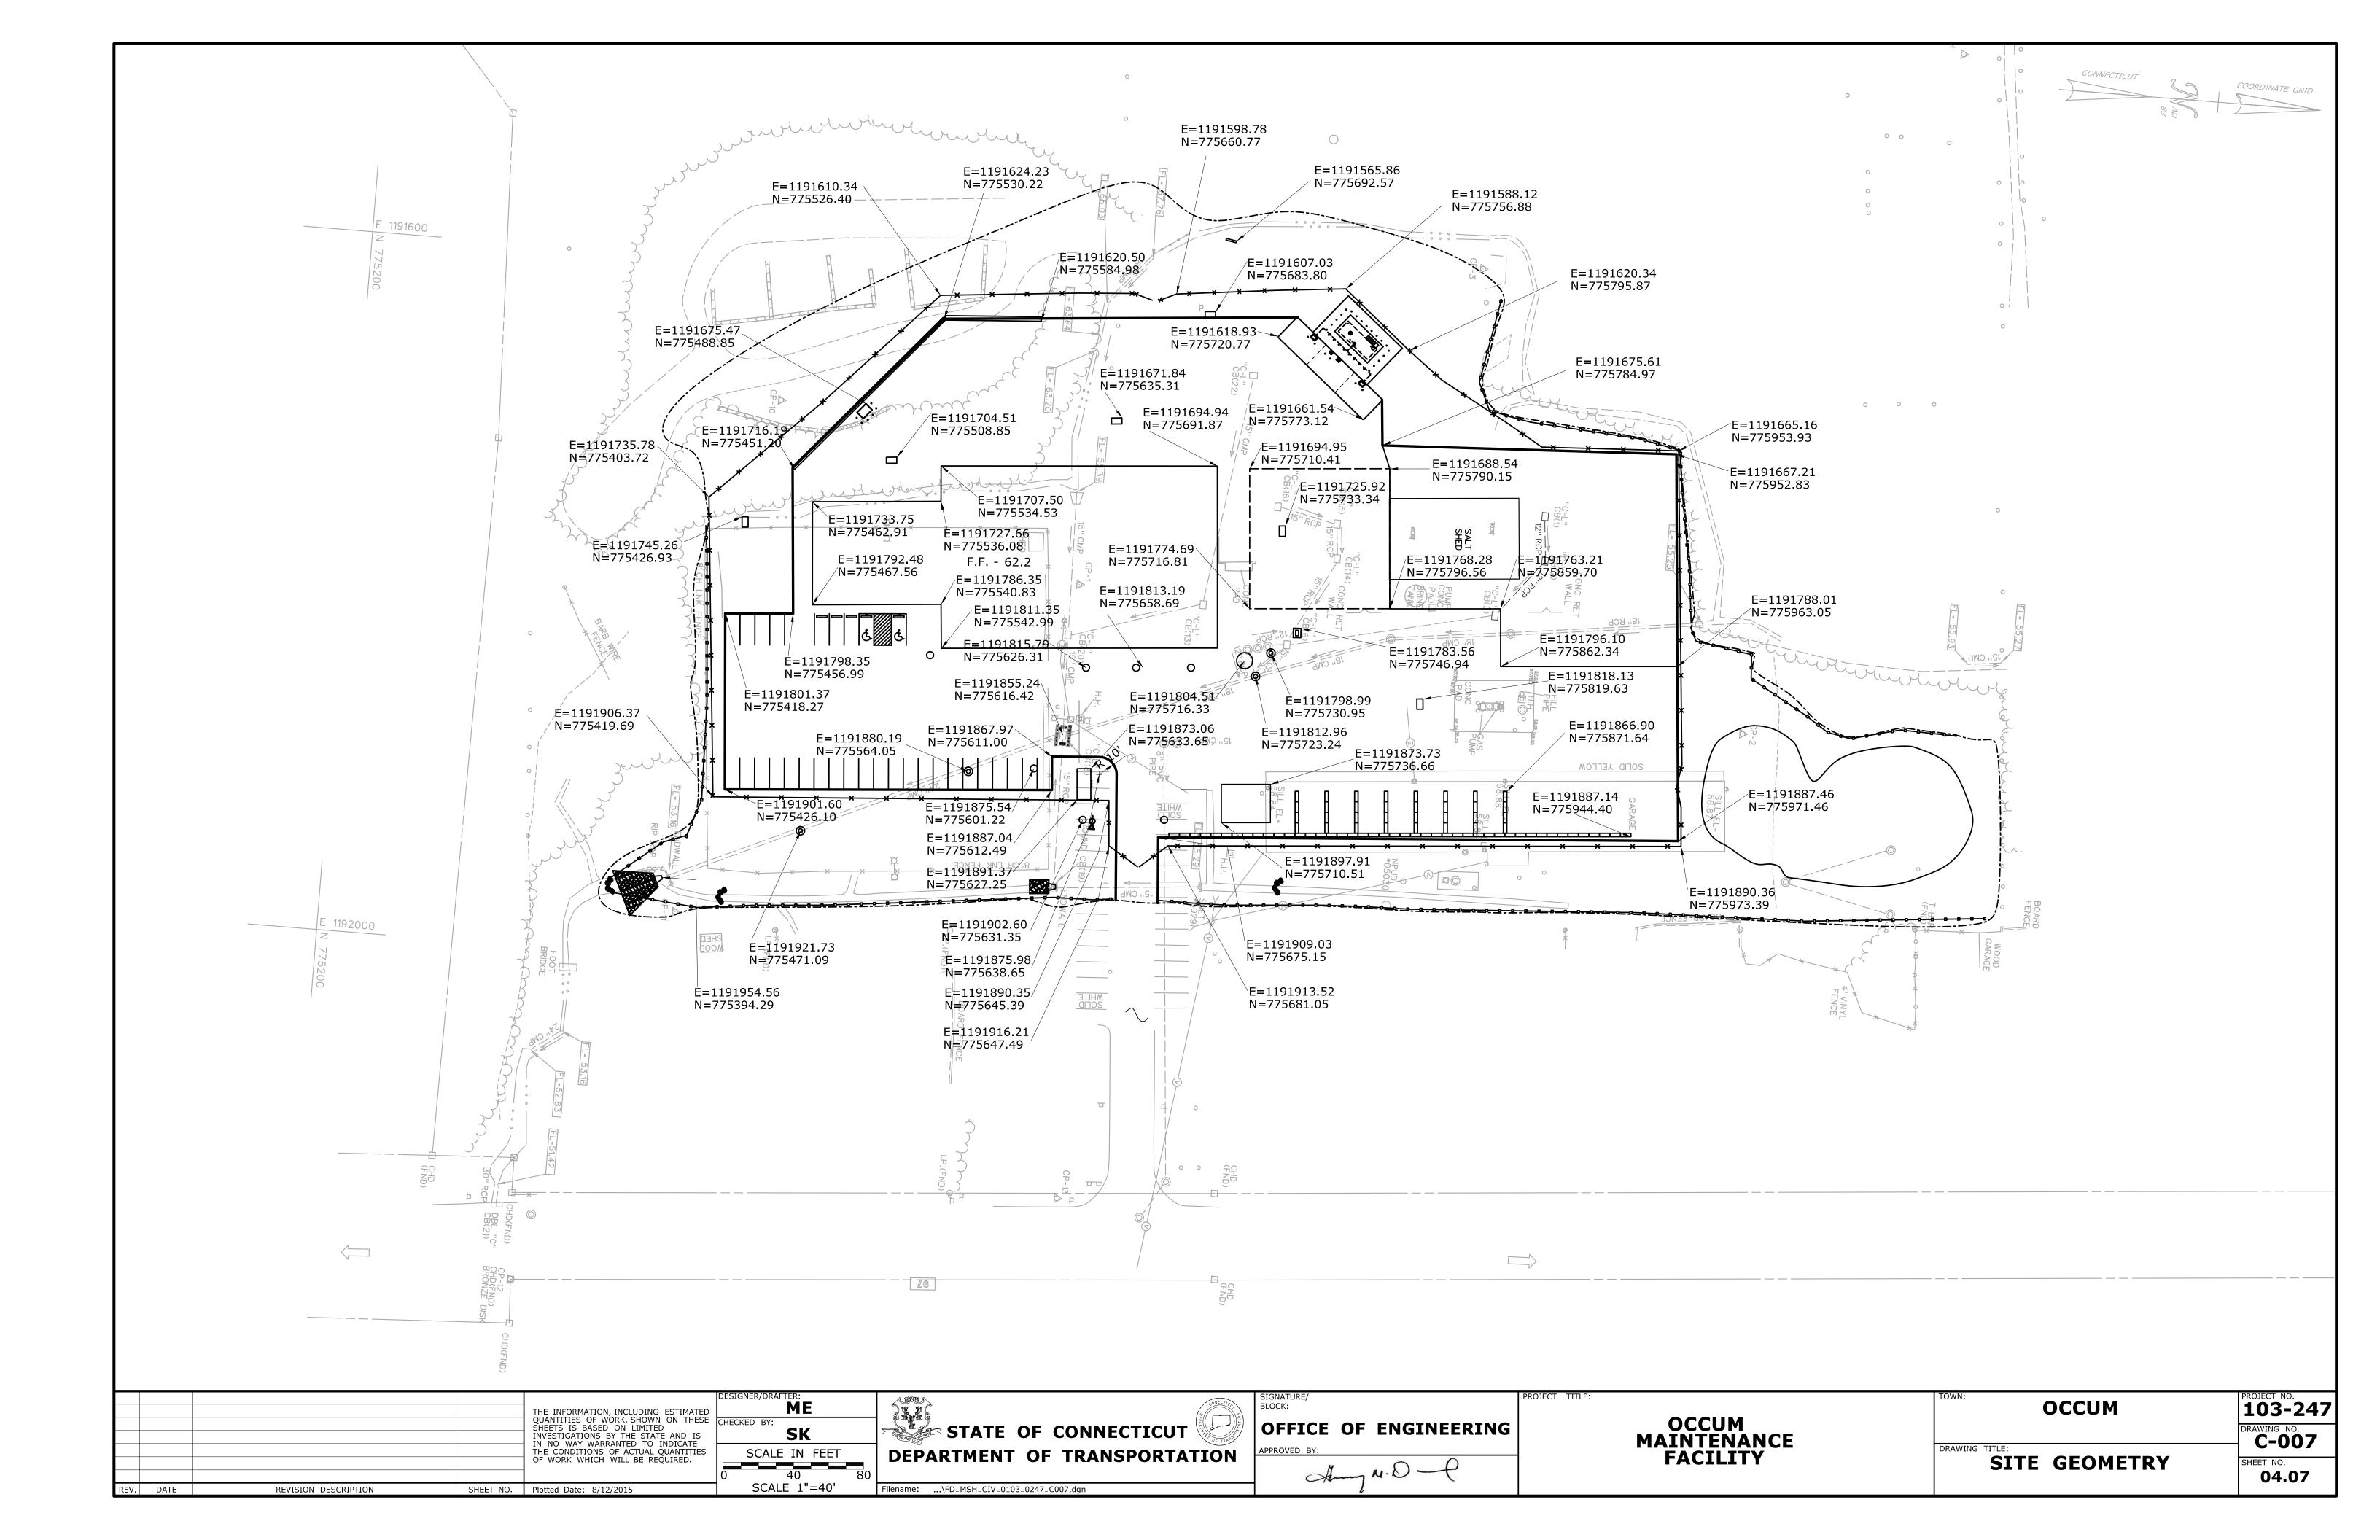

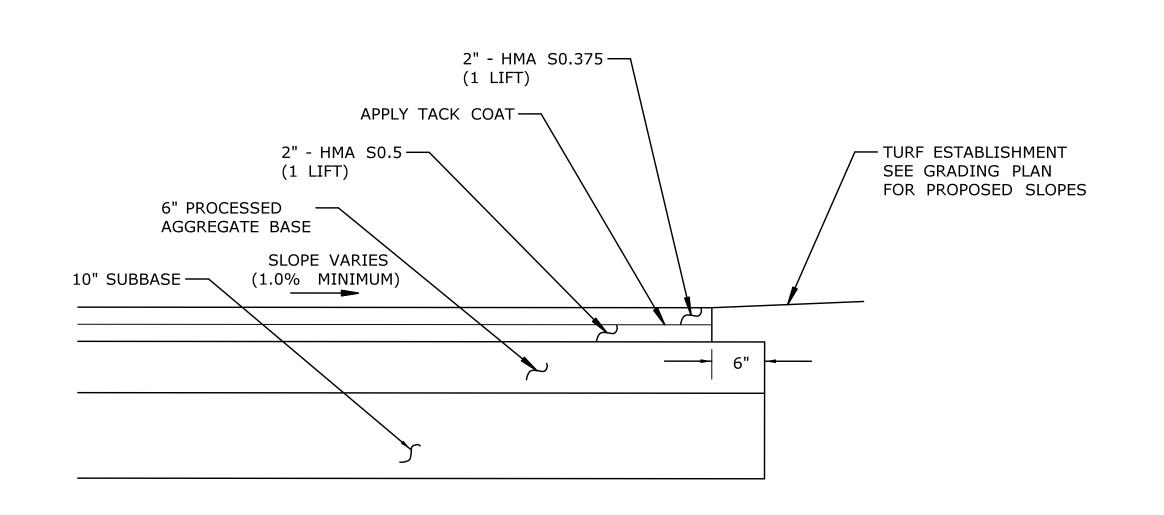


## -8.625" O.D. STEEL PIPE SCHEDULE 80 - PIPE TO BE FILLED WITH CONCRETE FINISHED GRADE POURED CONCRETE NOTES:

1. BOLLARDS SHALL BE COVERED WITH  $\frac{1}{4}$ " YELLOW POLYETHYLENE COVER. 2. TRIM BOLLARD COVER.

#### **BOLLARD**


#### NOT TO SCALE

#### **BITUMINOUS CONCRETE PAVEMENT - WITHOUT MEMBRANE** NOT TO SCALE

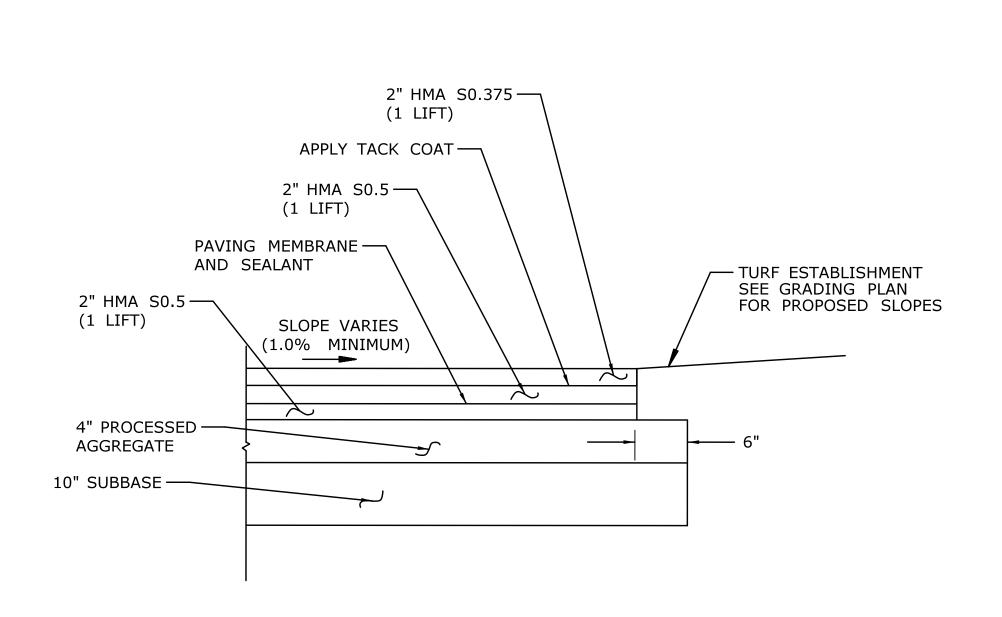



BITUMINOUS CONCRETE PAVING - WITH MEMBRANE

NOT TO SCALE

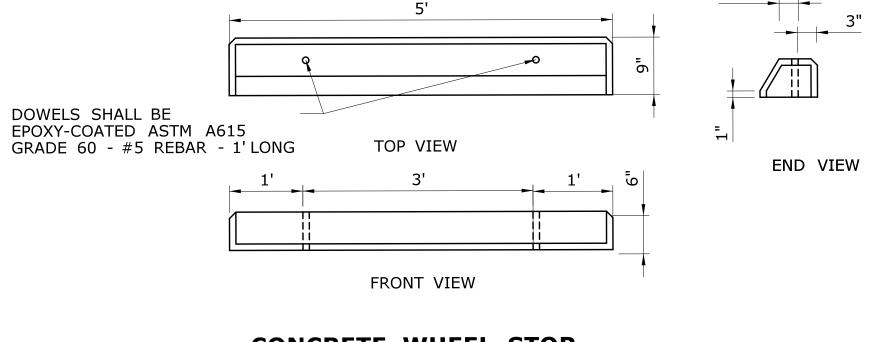


#### **CONCRETE WHEEL STOP** NOT TO SCALE

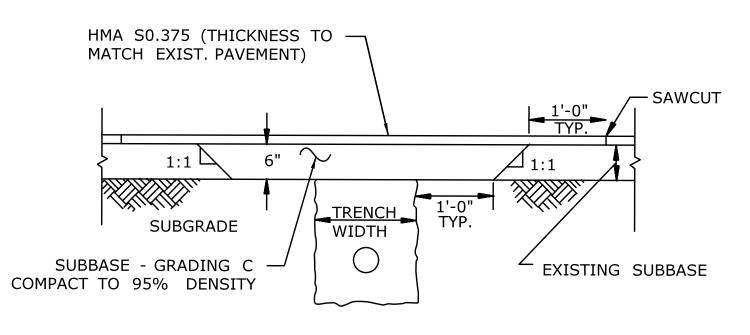

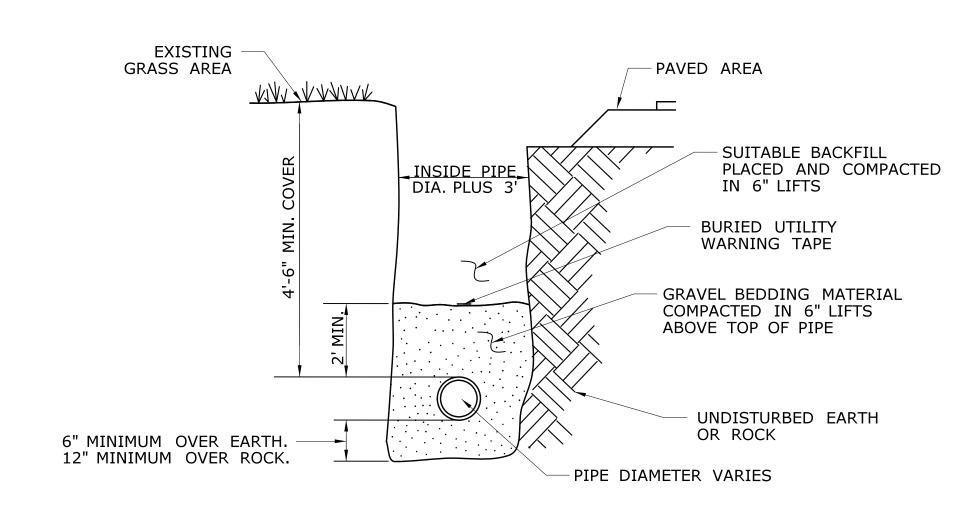


#### TYPICAL WATER SERVICE TRENCH SECTION NOT TO SCALE

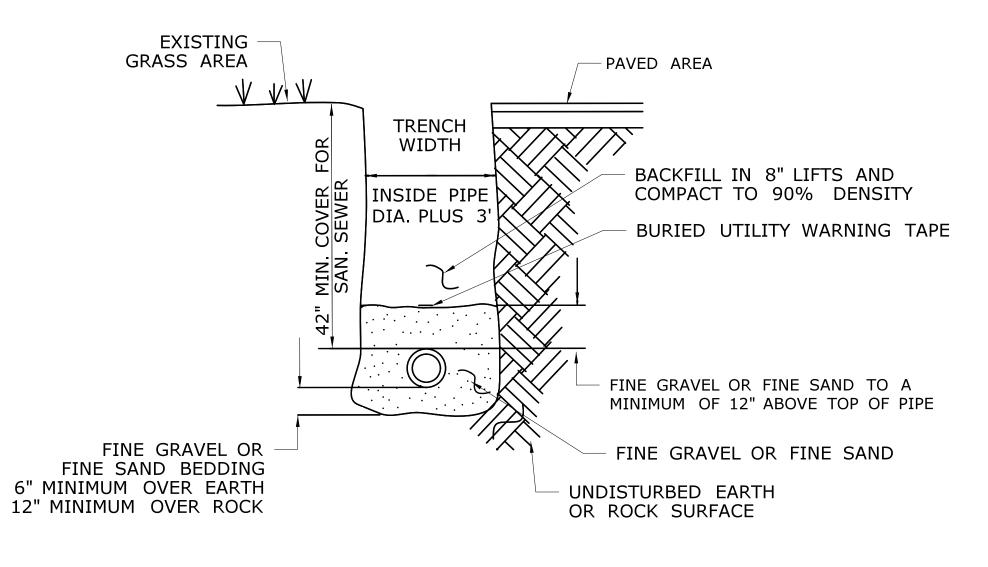


#### TYPICAL SEWER TRENCH SECTION NOT TO SCALE

#### PAVEMENT REPAIR TRENCH DETAIL NOT TO SCALE

THE INFORMATION, INCLUDING ESTIMATED OUANTITIES OF WORK, SHOWN ON THESE OF	ESIGNER/DRAFTER:  ME	CONNECTICAL	SIGNATURE/ BLOCK:	PROJECT TITLE:	TOWN: OCCUM	PROJECT NO. <b>103-247</b>
SHEETS IS BASED ON LIMITED INVESTIGATIONS BY THE STATE AND IS IN NO WAY WARRANTED TO INDICATE THE CONDITIONS OF ACTUAL QUANTITIES	SK	DEPARTMENT OF TRANSPORTATION	OFFICE OF ENGINEERING  APPROVED BY:	MAINTENANCE	DRAWING TITLE:	C-008
REV. DATE REVISION DESCRIPTION SHEET NO. Plotted Date: 8/12/2015	SCALE AS NOTED	Filename:\FD MSH CIV 0103 0247 C008.dgn	Amy M.D.	FACILITY	MISCELLANEOUS DETAILS - 1	SHEET NO. <b>04.08</b>

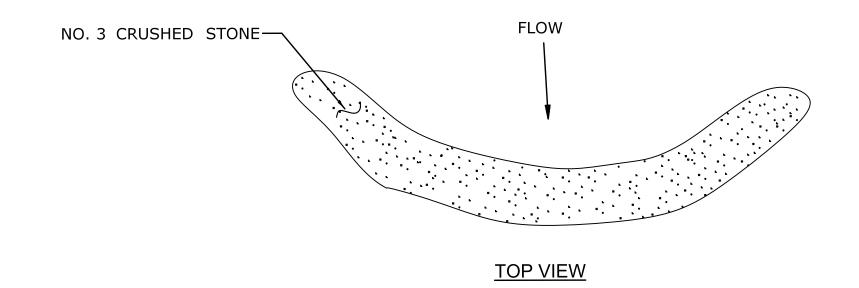

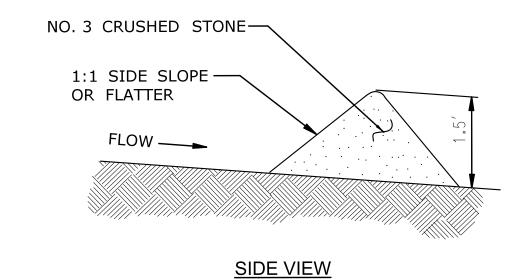


#### NOTES:

Filename: ...\FD\_MSH\_CIV\_0103\_0247\_C009.dgn

- 1. STONE CHECK DAM SHALL EXTEND THE FULL WIDTH OF THE BASIN, PLUS 18 INCHES KEYED INTO THE BANKS ON EACH SIDE.
- 2. THE HEIGHT OF THE CENTER OF THE CHECK DAM SHALL BE 6 INCHES LOWER THAN THE HEIGHT OF THE OUTER EDGES.

## STONE CHECK DAM NOT TO SCALE

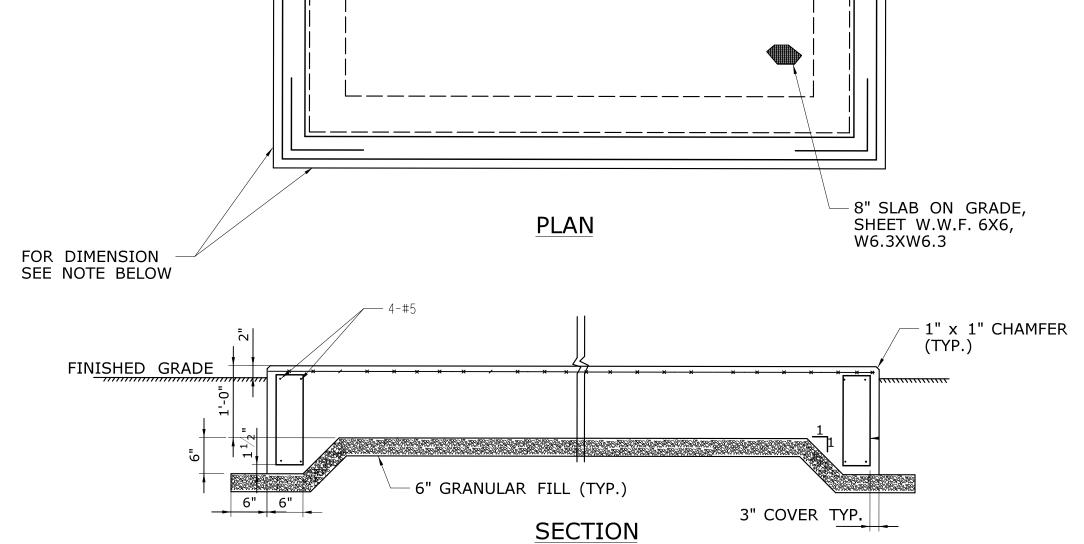

24" LAP AT TOP AND BOTTOM BARS

4-#5 BARS

(TYP. AT CORNERS)

2' (TYP) BOLLARD


EDGE

1. GENERATOR PAD TO BE 4.6'X 14.2'OR MANUFACTURER'S DIMENSIONS. REFER TO DWG C-003 AND C-007 FOR PAD LOCATION. 2. DUMPSTER PAD TO 24'X 22'. REFER TO DWG C-003 AND C-007 FOR PAD LOCATION.

3. CONCRETE SHALL BE CLASS F. REINFORCING SHALL BE EPOXY COATED ASTM A615 GRADE 60.

#### **CONCRETE PAD**

## 50' MIN. TRANSITION TO PAVEMENT — FLARE INTERSECTION AREA – TO ALLOW FOR TURNS CRUSHED STONE (NO. 3 — @ 6" THICK) PLAN VIEW

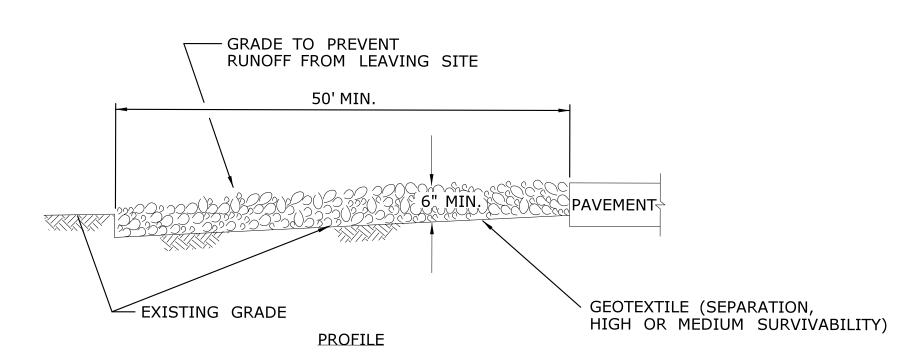

#### **ANTI-TRACKING PAD**


#### NOTE:

REVISION DESCRIPTION

REV. DATE

- 1. LOCATION TO BE APPROVED BY ENGINEER
- 2. ADJACENT PAVED ACCESS TO BE CLEANED ONCE A DAY.
- 3. MUD MUST BE REMOVED FROM ALL CONSTRUCTION VEHICLES BEFORE ENTERING PUBLIC ROADS.
- 4. PROVISIONS MUST BE MADE TO INTERCEPT THE WASH WATER AND TRAP SEDIMENT BEFORE IT IS CARRIED OFF-SITE.


SHEET NO. Plotted Date: 8/12/2015

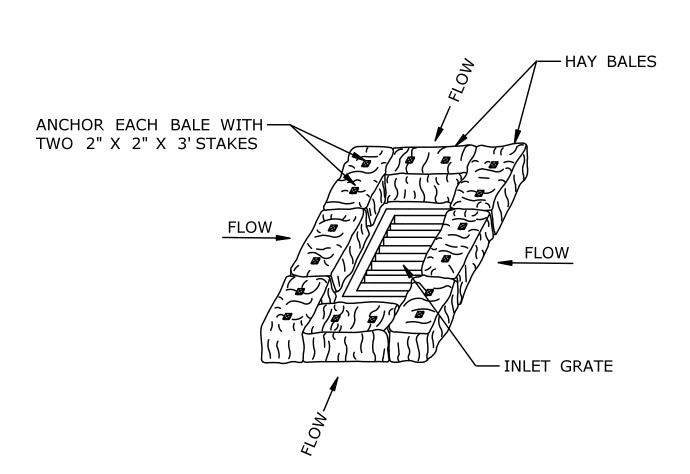

#### HAY BALE INSTALLATION AT CATCH BASIN


NOT TO SCALE

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DEV DATE REVISION DESCRIPTION SH	OF WORK WHICH WILL BE REQUIRED.  SCALE AS N		Amy M.D.	FACILITY	MISCELLANEOUS DETAILS - 2	SHEET NO. <b>04.09</b>

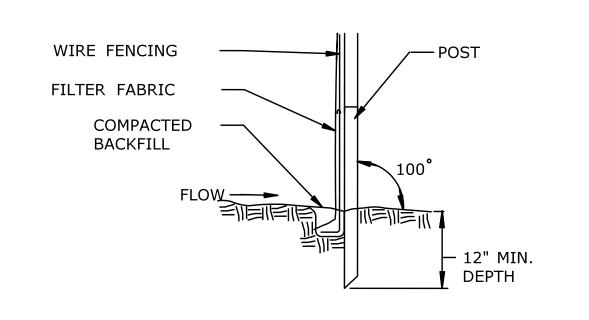

- PLAN VIEW
- 1. SET POSTS AS SHOWN AND EXCAVATE A 6" X 6" TRENCH ON UPSLOPE OF POST LINE
- 2. STAPLE THE WIRE MESH FENCING TO POSTS.
- 3. ATTACH FILTER FABRIC TO THE WIRE FENCING AND EXTEND THE FABRIC INTO THE TRENCH AS SHOWN.
- 4. BACKFILL THE TRENCH AND COMPACT THE EXCAVATED SOIL.

**DETAIL** 

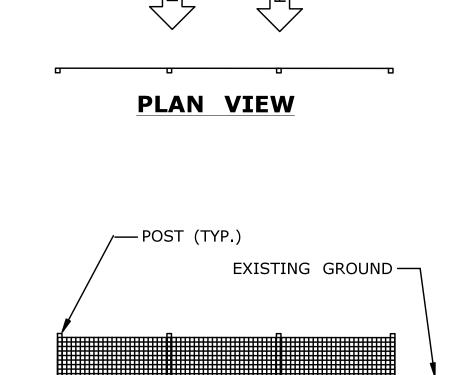

**ELEVATION VIEW** 

1. ALL PAVEMENT STRIPING SHOWN SHALL BE 4" WIDE WHITE MARKINGS UNLESS OTHERWISE INDICATED.

PAINTING FOR PARKING STALLS

NOT TO SCALE

INSTALL ACCESSIBLE PARKING SIGN-

(CDOT SIGN #31-0648)

SIDE OF BUILDING

-4" WHITE -

LINE

CONCRETE CURB STOP -

4" PAINTED WHITE LINE -

BOTH TO BE INSTALLED ON

(CDOT SIGN #31-0629P) AND VAN ACCESSIBLE PARKING SIGN


ACCESSIBLE PARKING SPACE SYMBOL

NOT TO SCALE

INSTALL ACCESSIBLE PARKING SIGN

CENTER SYMBOL ACROSS
WIDTH OF STALL

## FILTER FABRIC SYSTEM FOR SEDIMENTATION CONTROL ON SLOPES NOT TO SCALE

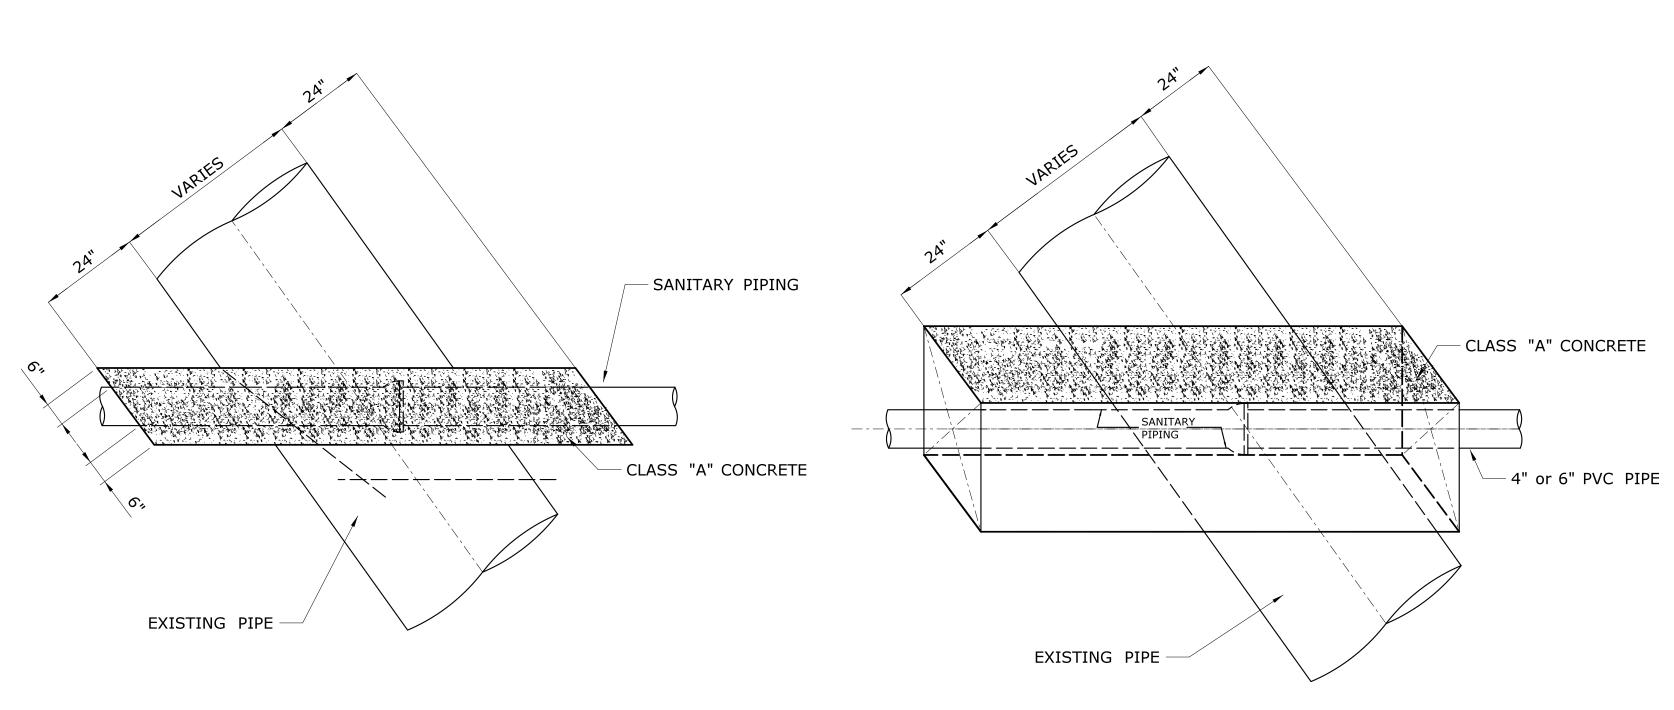


## CONCRETE ENCASEMENT OVER EXISTING STORM DRAINAGE PIPE


ME

SCALE AS NOTED

NOT TO SCALE

NOTE: TO BE UNDER THE MAJOR LUMP SUM ITEM (CLASS 'A' CONCRETE)

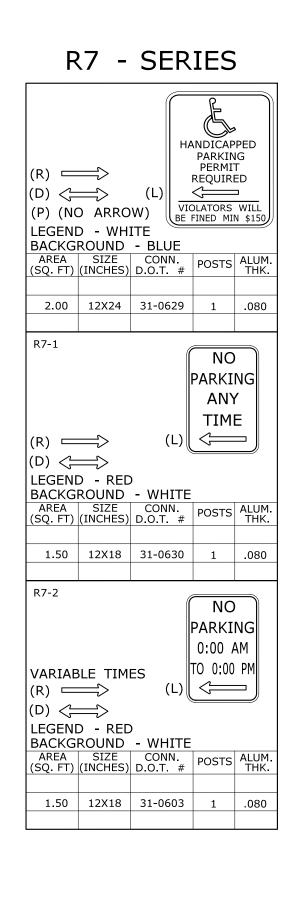

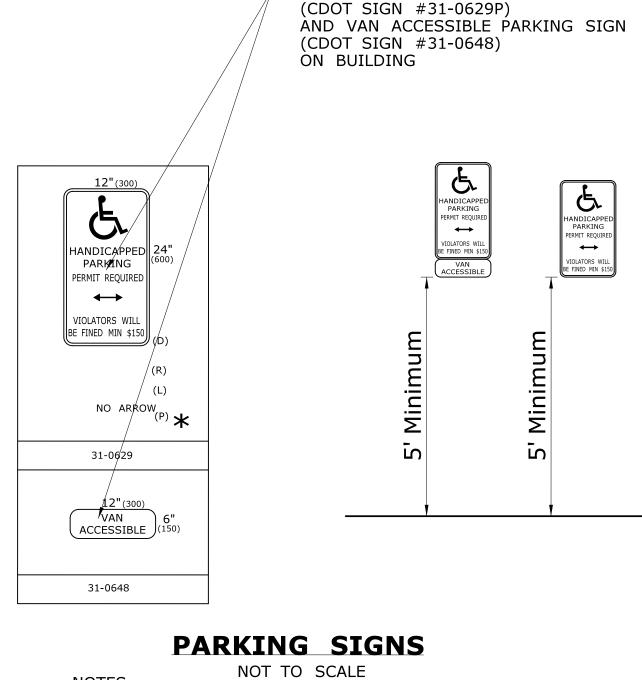

NOTES:

**5**:

- SIGN TO BE LOCATED ON BUILDING.
   ALL SIGNS TO BE CENTERED ON PARKING SPACE.
- 3. SIGN TO BE PLACED 5' ABOVE THE GROUND.

	THE INFORMATION, INCLUDING ESTIMATED QUANTITIES OF WORK, SHOWN ON THESE SHEETS IS BASED ON LIMITED INVESTIGATIONS BY THE STATE AND IS IN NO WAY WARRANTED TO INDICATE THE CONDITIONS OF ACTUAL QUANTITIES OF WORK WHICH WILL BE REOUIRED.
	OF WORK WHICH WILL BE REQUIRED.

SHEET NO. Plotted Date: 8/12/2015

REVISION DESCRIPTION

REV. DATE

STATE OF CONNECTICUT DEPARTMENT OF TRANSPORTATION

Filename: ...\FD\_MSH\_CIV\_0103\_0247\_C010.dgn

SIGNATURE/
BLOCK:

OFFICE OF ENGINEERING

APPROVED BY:

OCCUM MAINTENANCE FACILITY OCCUM

DRAWING TITLE:

MISCELLANEOUS
DETAILS - 3

PROJECT NO.


103-247

DRAWING NO.

C-010


SHEET NO.

04.10

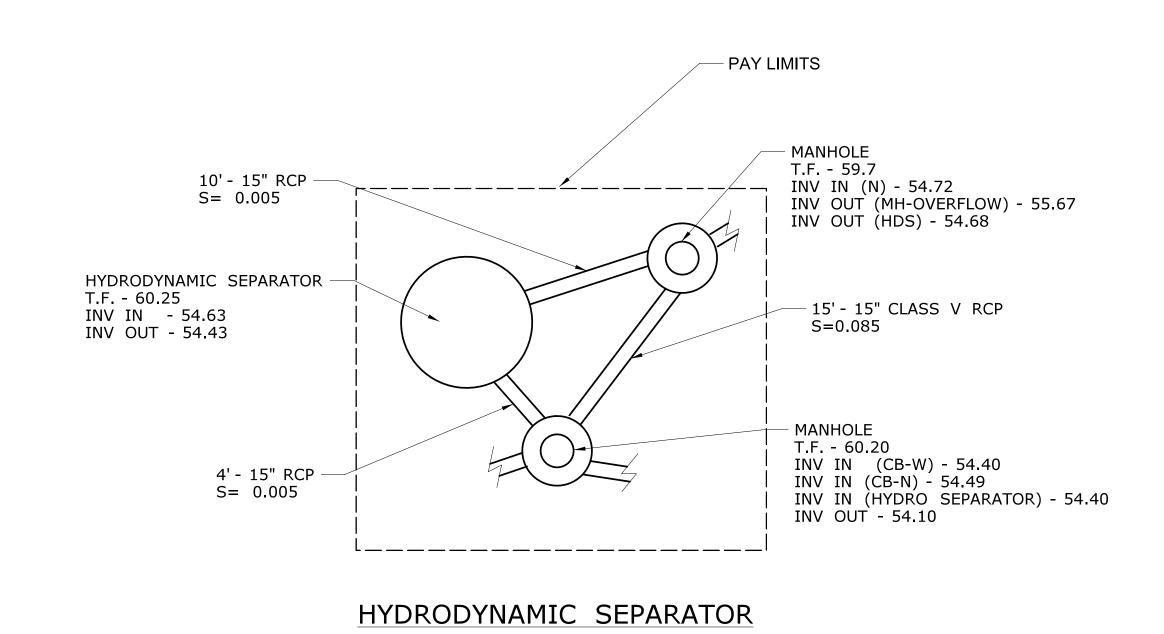


PAY LIMITS

NOT TO SCALE

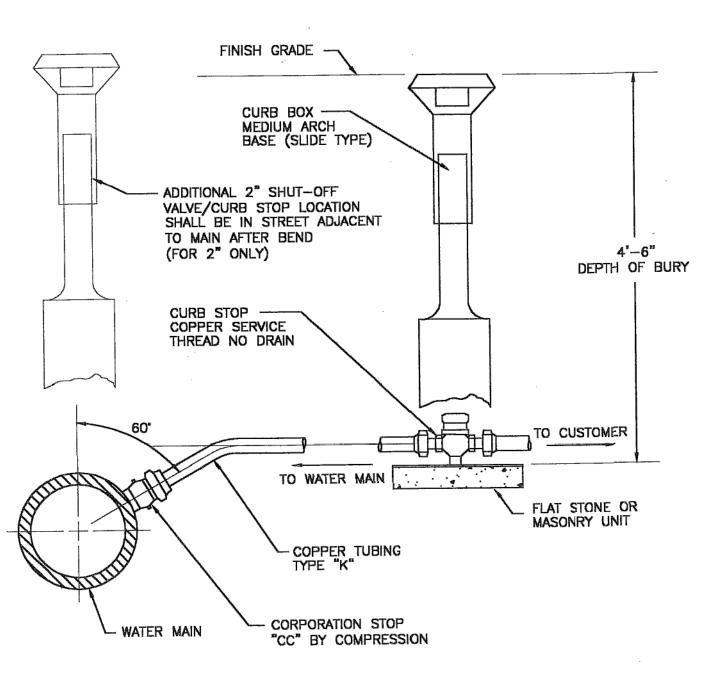

WATER SERVICE CONNECTION NOT TO SCALE

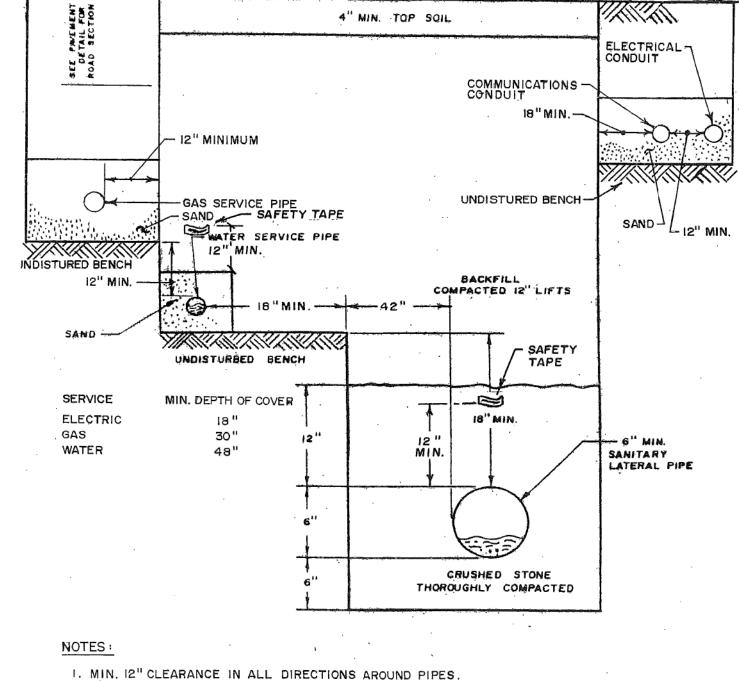

1. MIN. 12" CLEARANCE IN ALL DIRECTIONS AROUND PIPES,

SEED & MULCH -

- 2. SANDPAD 4'-6" ABOVE, BELOW, AND SIDES OF PIPE.
- 3. GAS AND ELECTRICAL SHOULD BE HORIZONTALLY SEPARATED BY A MIN. OF 36",

#### RESIDENTIAL WATER, SEWER, GAS, ELECTRIC COMBINED TRENCH

NOT TO SCALE

PROJECT NO.

103-247

DRAWING NO.


C-011


SHEET NO. **04.11** 

**OCCUM** 

MISCELLANEOUS
DETAILS - 4

			THE INFORMATION, INCLUDING ESTIMATED QUANTITIES OF WORK, SHOWN ON THESE SHEETS IS BASED ON LIMITED INVESTIGATIONS BY THE STATE AND IS	DESIGNER/DRAFTER:  MC  CHECKED BY:  ME	STATE OF CONNECTICUT	SIGNATURE/ BLOCK:  OFFICE OF ENGINEERING	PROJECT TITLE:  OCCUM MAINTENANCE
			IN NO WAY WARRANTED TO INDICATE THE CONDITIONS OF ACTUAL QUANTITIES OF WORK WHICH WILL BE REQUIRED.	SCALE AS NOTED	DEPARTMENT OF TRANSPORTATION	APPROVED BY:	FACILITY
REV. DATE	REVISION DESCRIPTION	SHEET NO.	Plotted Date: 8/12/2015	1	Filename:\FD_MSH_CIV_0103_0247_C011.dgn	1 1	

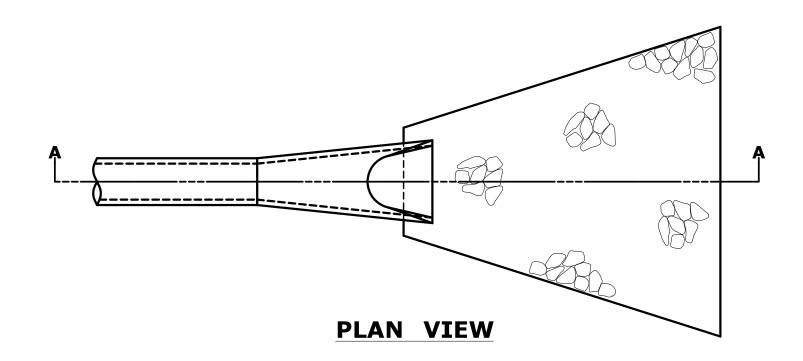

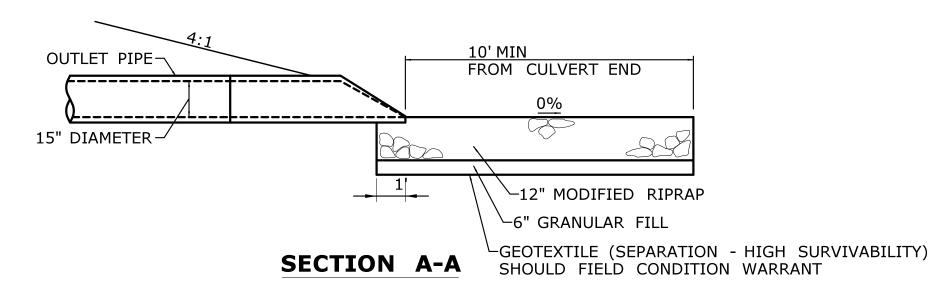


#### MODIFIED RIPRAP SPLASH PAD

NOT TO SCALE


NOTE:

1. TO BE PAID AS MODIFIED RIPRAP.

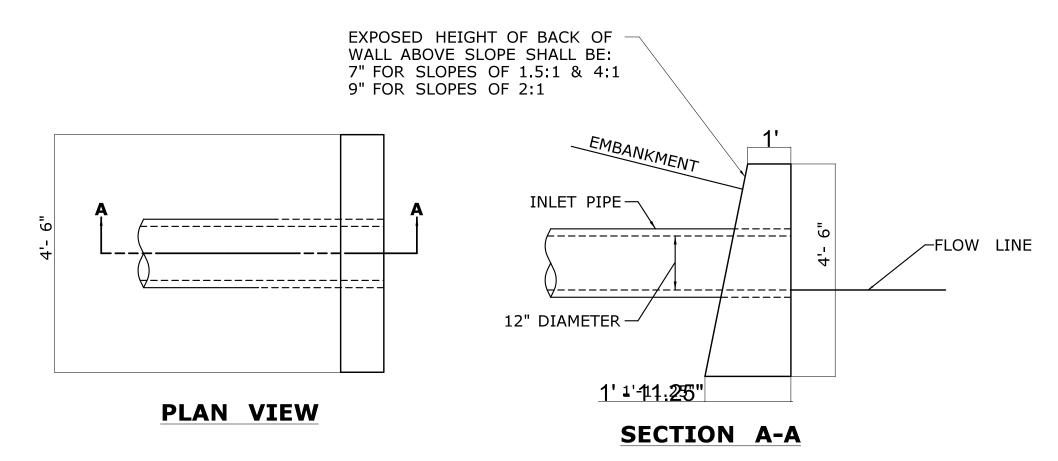


## CONCRETE ENDWALL NOT TO SCALE

NOTE: TO BE UNDER THE MAJOR LUMP SUM ITEM (CLASS 'A' CONCRETE)

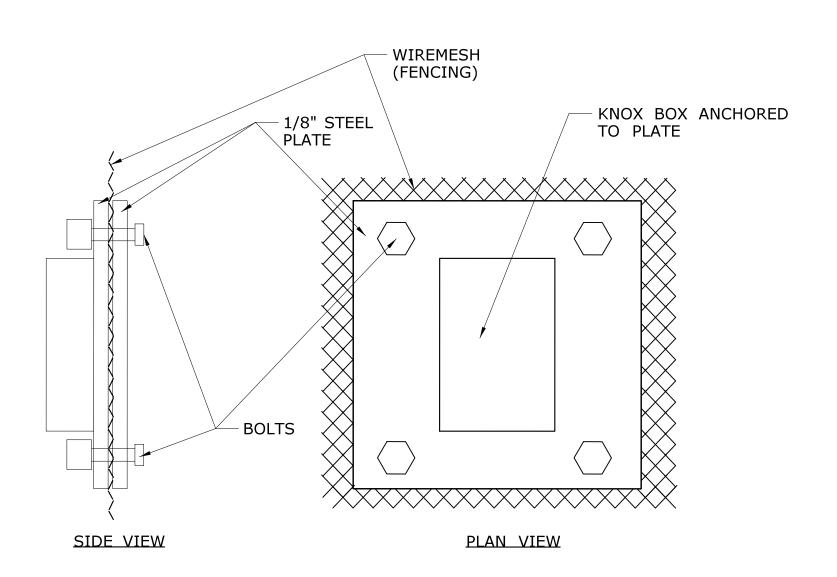


### KNOX BOX INSTALLATION NOT TO SCALE

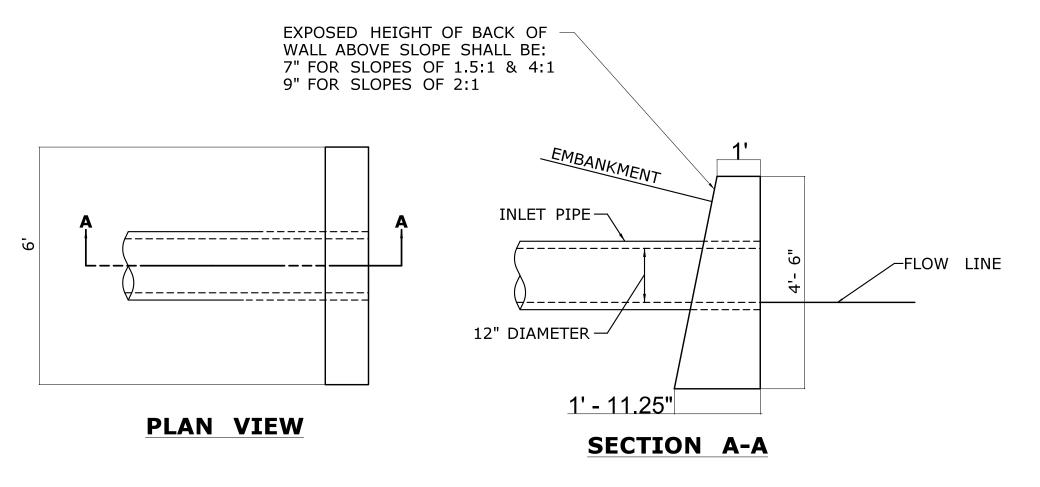

### SPECIAL ENDWALL NOT TO SCALE

NOTE: TO BE UNDER THE MAJOR LUMP SUM ITEM (CLASS 'A' CONCRETE)


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OF WORK WHICH WILL BE REQUIRED.	SCALE AS NOTED	DEPARTMENT OF TRANSPORTATION	Amy N.O.	FACILITY	MISCELLANEOUS DETAILS - 5	SHEET NO. <b>04.12</b>
REV. DATE REVISION DESCRIPTION SHEET NO. Plotted Date: 8/12/2015		Filename:\FD_MSH_CIV_0103_0247_C012.dgn	l		DETAILS 5	

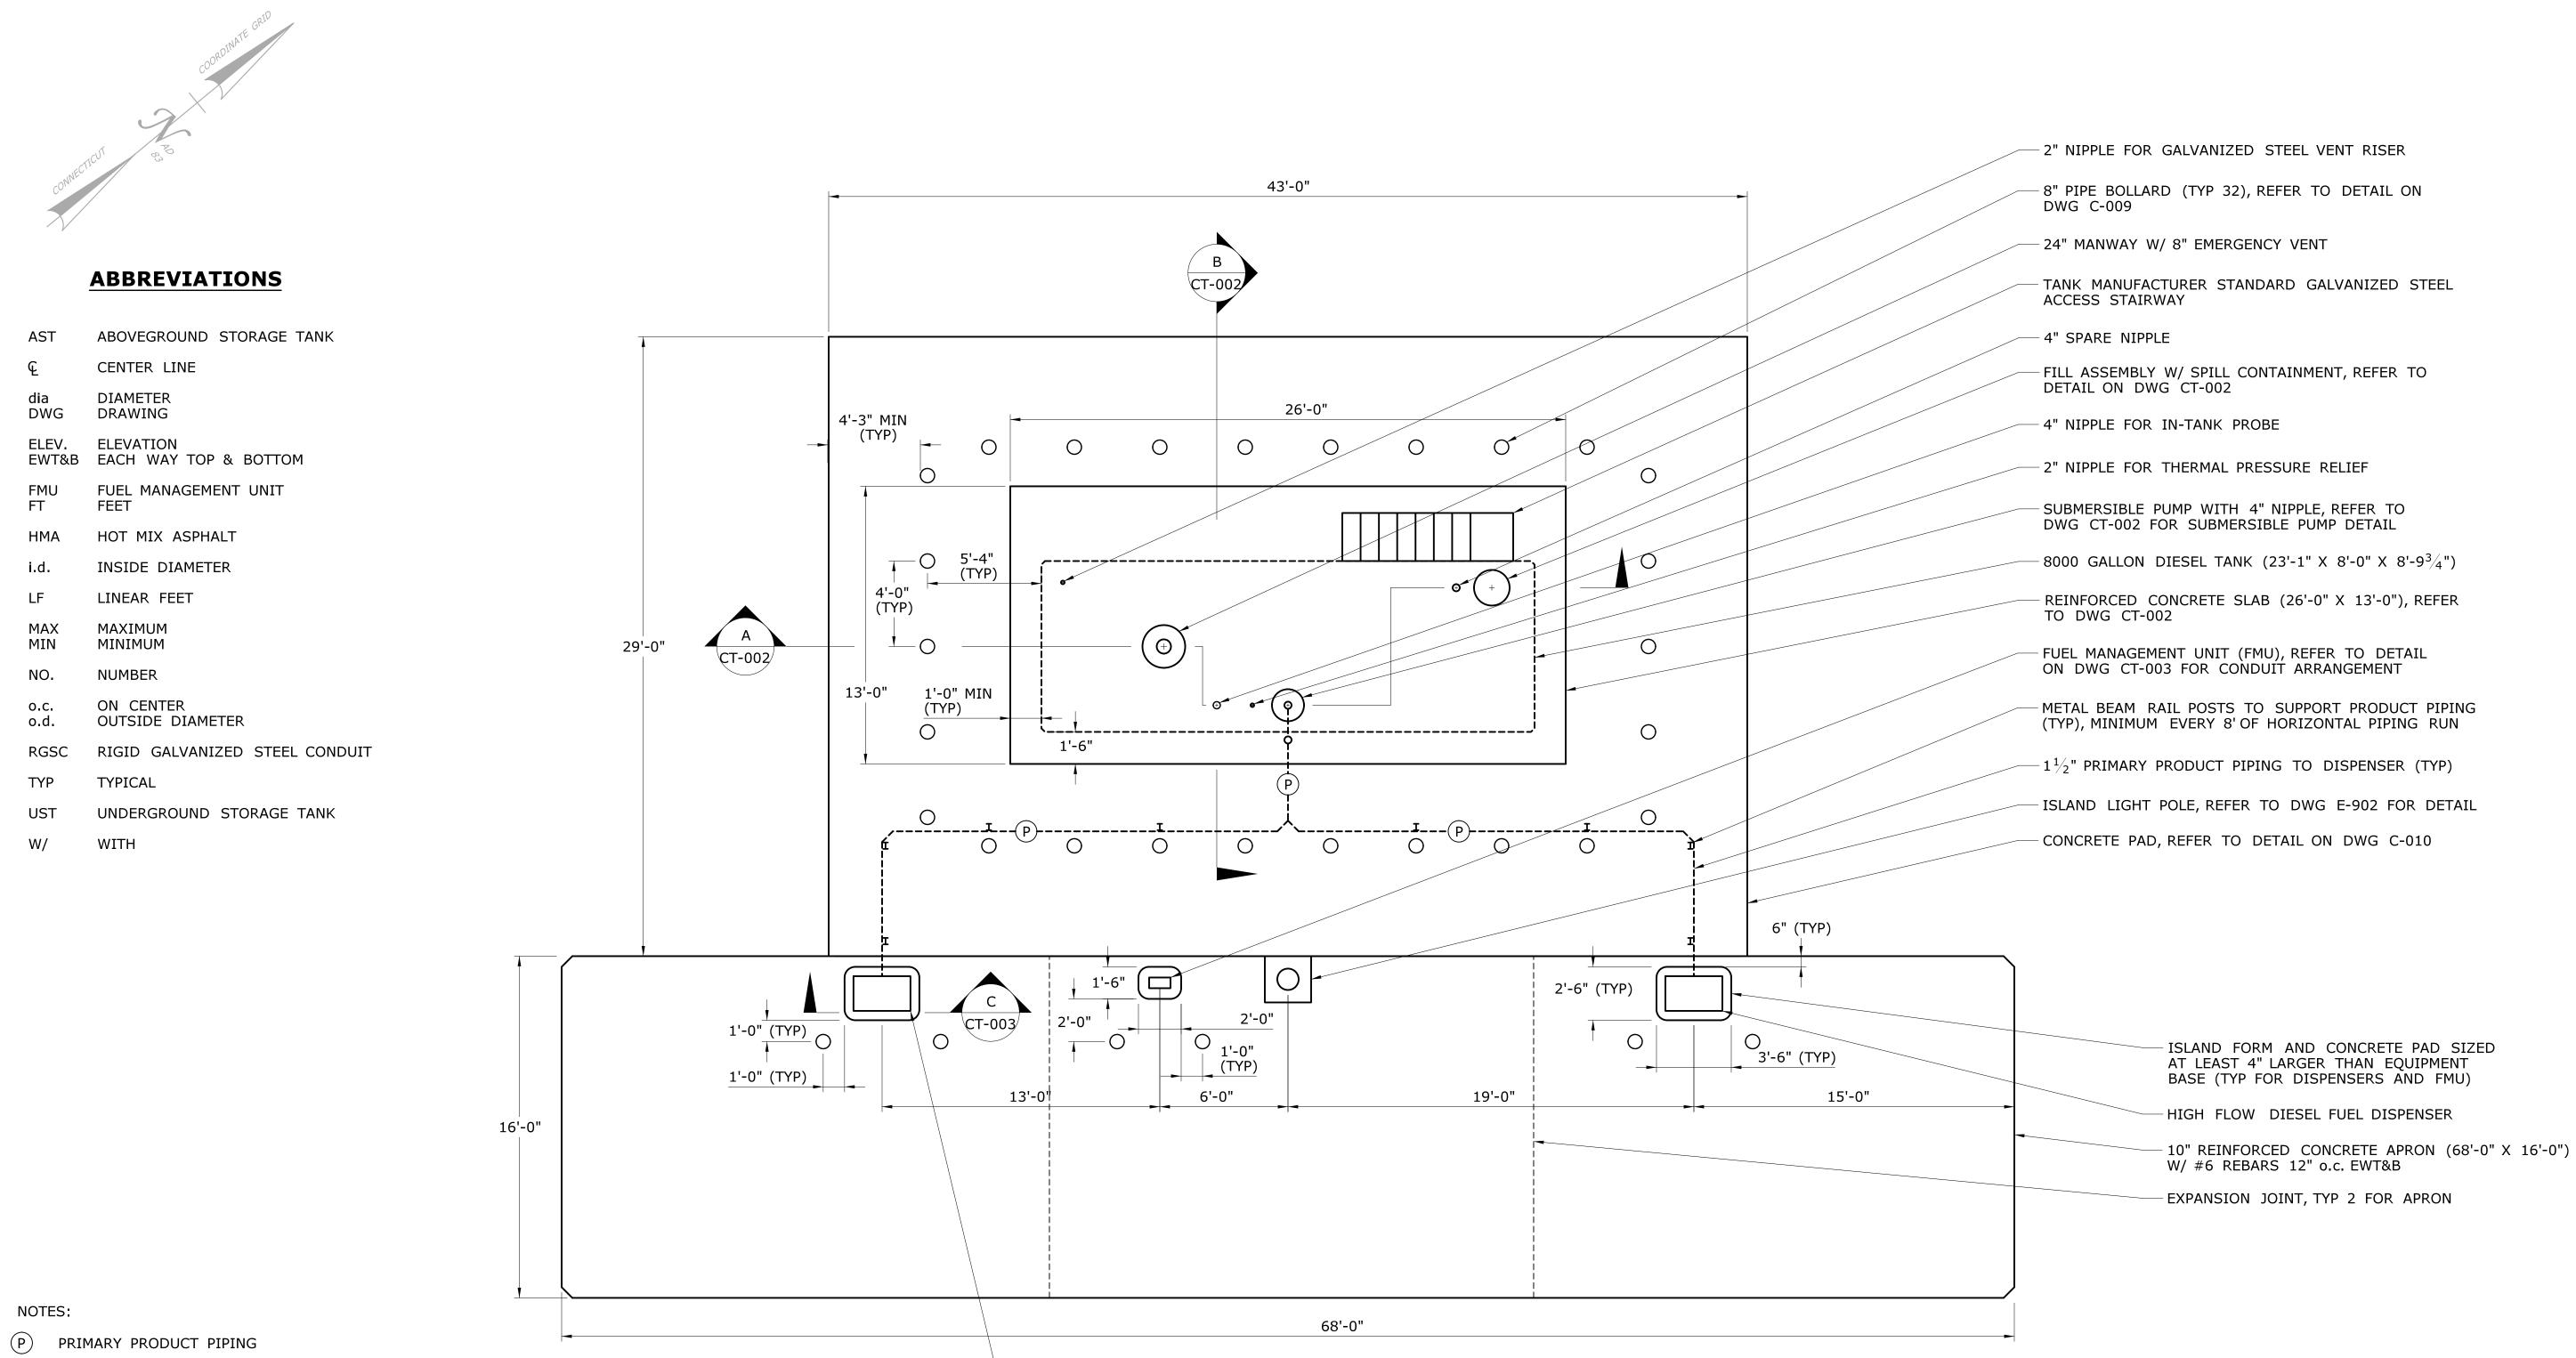

- 1. THE DESIGNED TANK DIMENSIONS AND SUPPORT LEG LOCATIONS ARE BASED ON CONVAULT. ACTUAL SLAB DIMENSIONS SHALL BE SIZED BASED ON THE APPROVED TANK DIMENSIONS AND SUPPORT LEG LOCATIONS.
- 2. THE TANK NIPPLE ARRANGEMENT IS BASED ON CONVAULT TANKS. ACTUAL TANK NIPPLE ARRANGEMENT SHALL BE DESIGNED AS NECESSARY BASED ON THE APPROVED TANK MANUFACTURER.
- 3. REFER TO DWG CT-002 FOR MOTOR FUEL TANK AND DWG CT-003 FOR MOTOR FUEL ISLAND DETAILS.
- 4. INSTALL SALVAGED STATION SIGNS TO FENCE AS DIRECTED BY ENGINEER.
- 5. SUPPORT PRODUCT PIPING WITH GALVANIZED STRUT MAST AND PIPE CLAMP MOUNTED TO THE TANK, TANK PAD, AND METAL BEAM RAIL POSTS.
- 6. LOCATE FIRE EXTINGUISHER IN FIRE-PROTECTION CABINET AS DIRECTED BY ENGINEER.

	THE INFORMATION, INCLUDING ESTIMATED OLIANTITIES OF WORK SHOWN ON THESE	DESIGNER/DRAFTER: NAR	CONNECTICAL STATE OF THE CONNECTICAL STATE OF	SIGNATURE/ PROJECT T BLOCK:	TITLE:	OCCUM	103-247
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	OF WORK WHICH WILL BE REQUIRED.	SCALE 1/4" = 1'-0"	DEPARTMENT OF TRANSPORTATION	Amy M.D.	FACILITY	MOTOR FUEL ISLAND PLAN	SHEET NO. <b>04.13</b>
REV. DATE	REVISION DESCRIPTION SHEET NO. Plotted Date: 8/12/2015		Filename:\FD_MSH_CIV_0103_0247_CT001.dgn	l		ISLAND FLAN	

- DIESEL FUEL DISPENSER

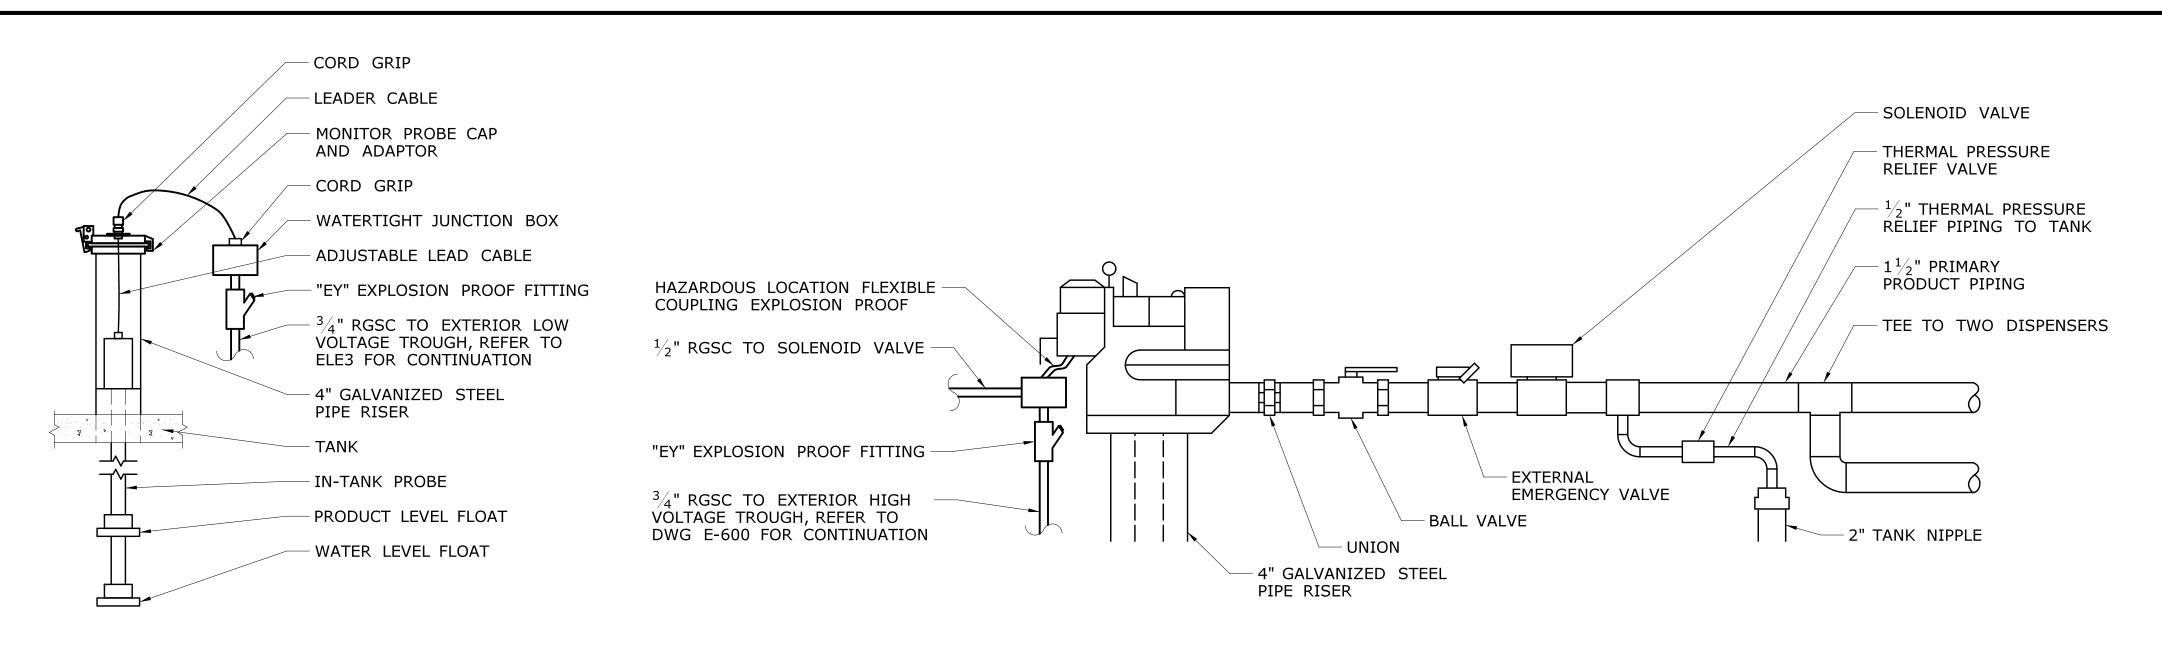

#### IN-TANK PROBE DETAIL

#### SUBMERSIBLE PUMP DETAIL

NOTES:

1. THE DESIGNED TANK DIMENSIONS AND SUPPORT LEG LOCATIONS ARE

3. ALL CONDUITS SHALL BE PROVIDED WITH EXPLOSION PROOF FITTINGS AND SEALED AS REQUIRED IN ACCORDANCE WITH NFPA 70.


2. THE TANK NIPPLE ARRANGEMENT IS BASED ON CONVAULT TANKS.

BASED ON THE APPROVED TANK MANUFACTURER.

BASED ON CONVAULT. ACTUAL SLAB DIMENSIONS SHALL BE SIZED BASED


ACTUAL TANK NIPPLE ARRANGEMENT SHALL BE DESIGNED AS NECESSARY

ON THE APPROVED TANK DIMENSIONS AND SUPPORT LEG LOCATIONS.

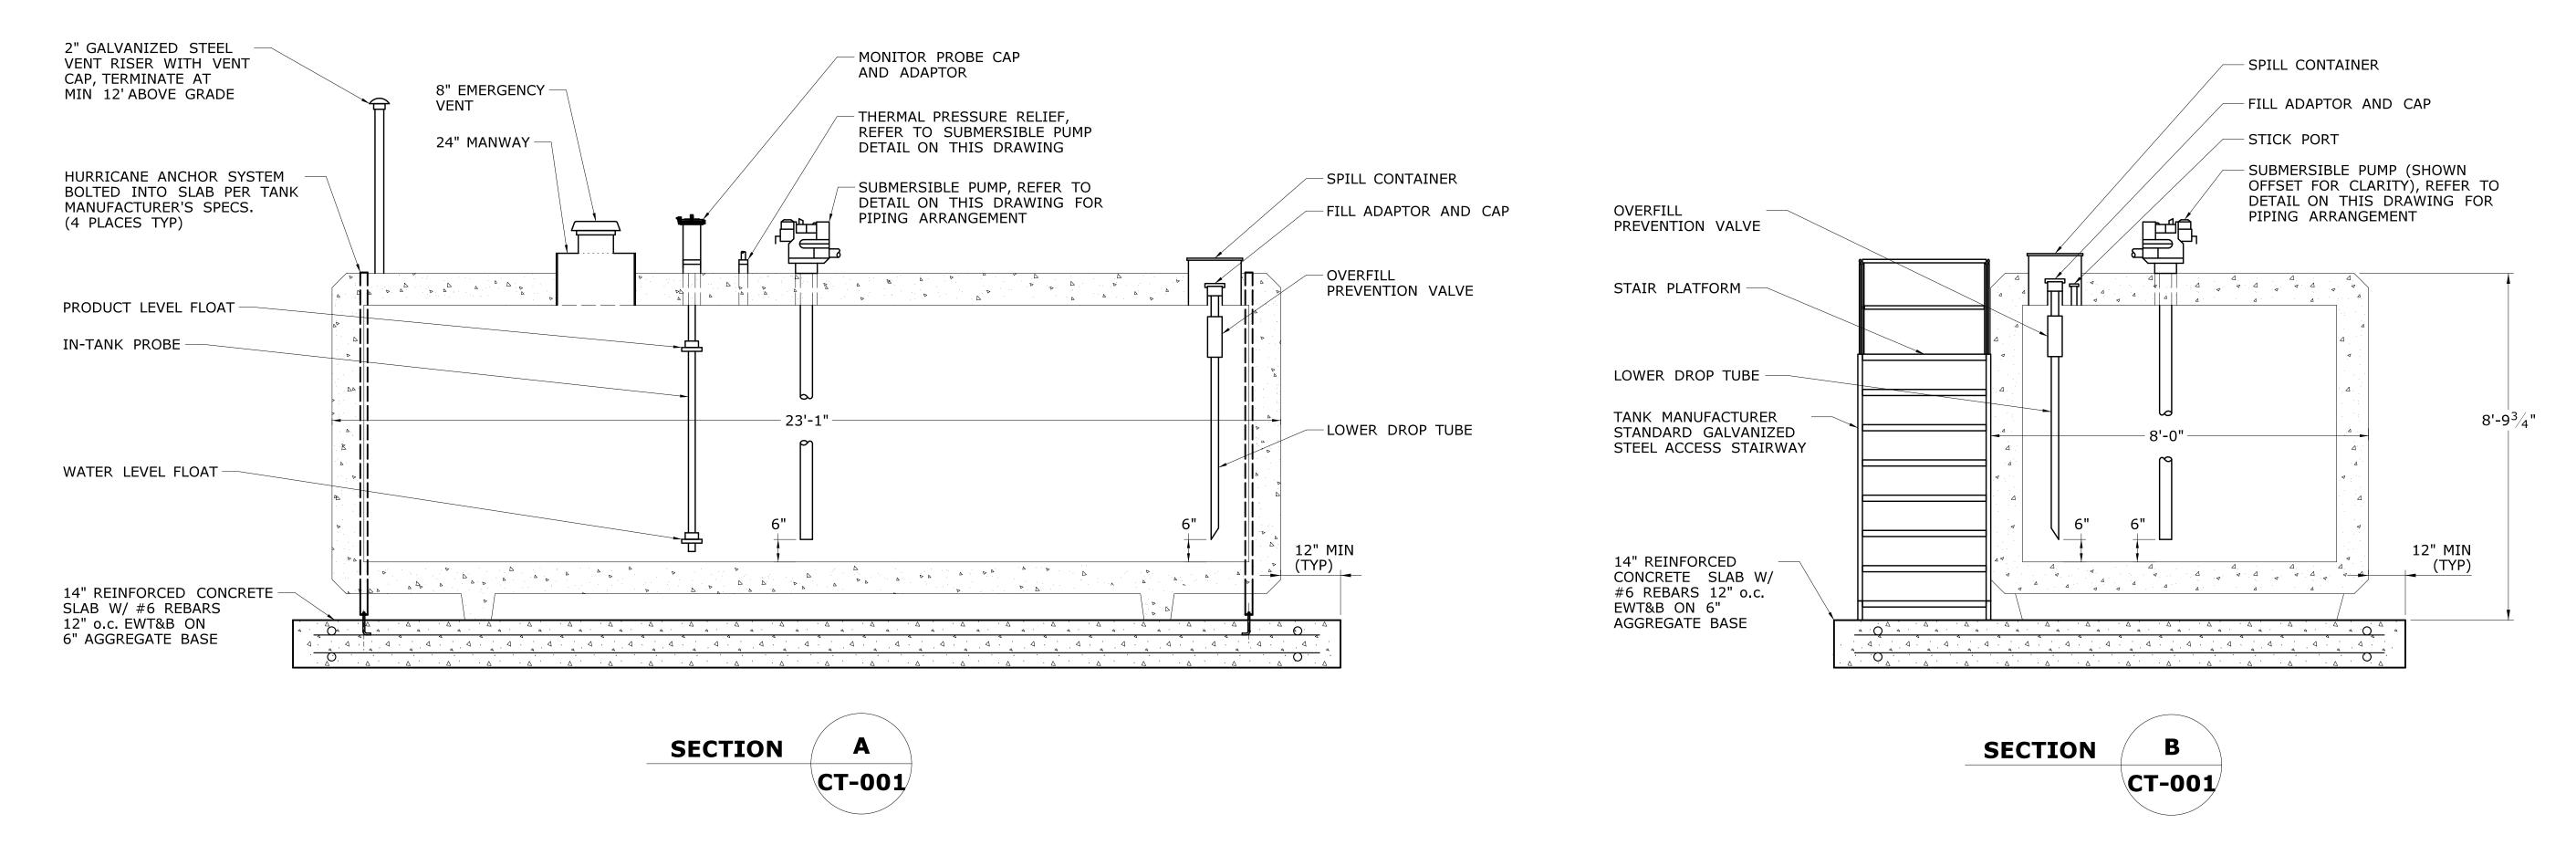


#### MOTOR FUEL ABOVEGROUND STORAGE TANK DETAIL

		THE INFORMATION, INCLUDING ESTIMATED QUANTITIES OF WORK, SHOWN ON THESE CHECKED BY:	CONNECTICIA CONNE	SIGNATURE/ BLOCK:	PROJECT TITLE:  OCCUM	OCCUM	PROJECT NO. 103-247
		SHEETS IS BASED ON LIMITED INVESTIGATIONS BY THE STATE AND IS IN NO WAY WARRANTED TO INDICATE  JAB	STATE OF CONNECTICUT	OFFICE OF ENGINEERING	MAINTENANCE	DRAWING TITLS	CT-002
		THE CONDITIONS OF ACTUAL QUANTITIES OF WORK WHICH WILL BE REQUIRED.	DEPARTMENT OF TRANSPORTATION	APPROVED BY:	FACILITY	MOTOR FUEL	SHEET NO.
REV.	DATE REVISION DESCRIPTION SHEET NO.	Plotted Date: 8/12/2015 NOT TO SCAI	Filename:\FD_MSH_CIV_0103_0247_CT002.dgn	- Amy M.D.		TANK DETAILS	04.14

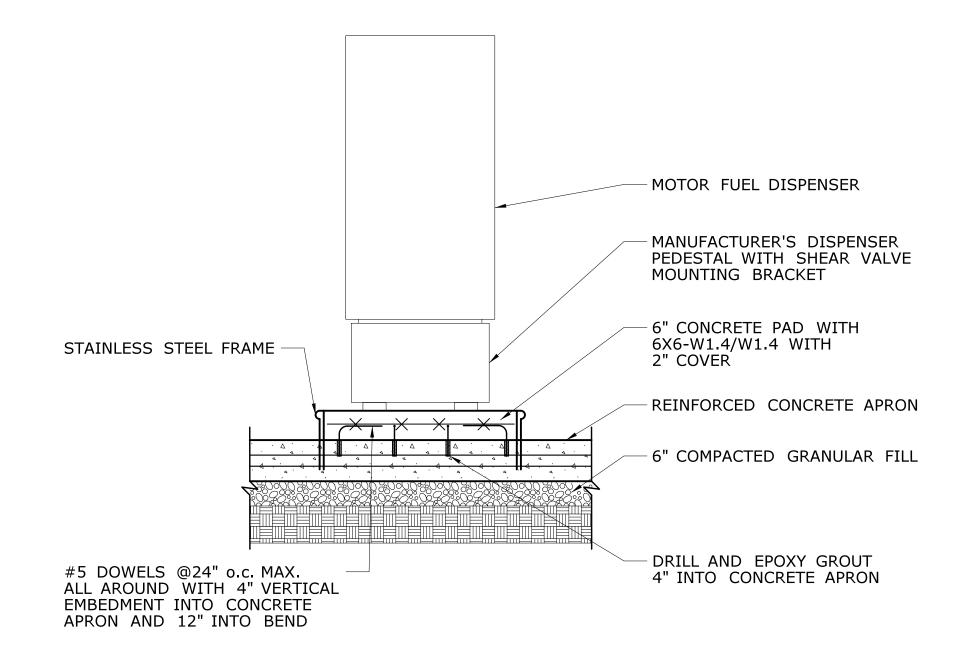

DISPENSER PAD AND APRON DETAIL


CT-002

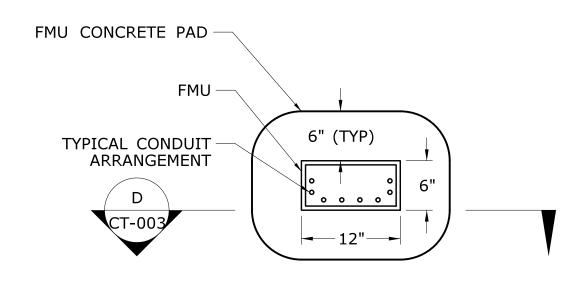


## FUEL MANAGEMENT UNIT (FMU) SETTING DETAIL

#### NOTES:

1. FMU SHALL BE SECURED TO CONCRETE WITH STAINLESS STEEL HARDWARE. SEAL BASE OF FMU TO CONCRETE WITH SILICONE TO FORM A WATERTIGHT SEAL.

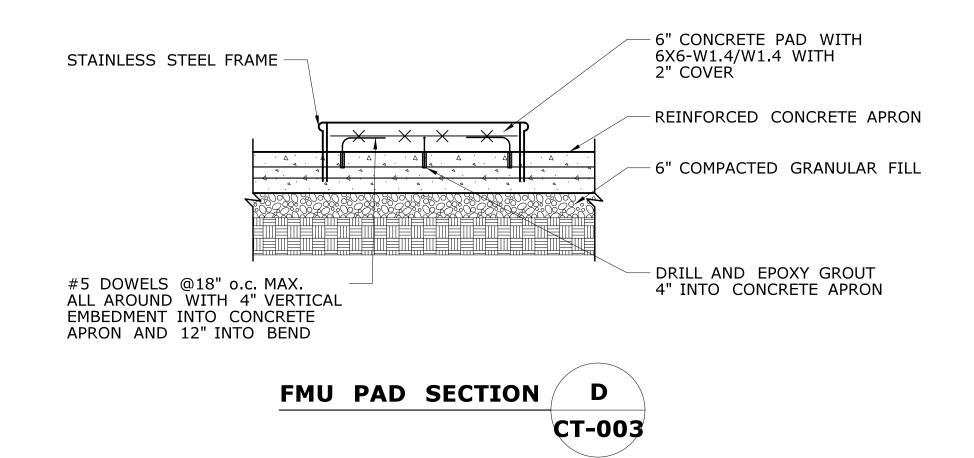

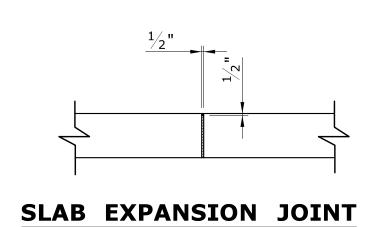

THE INFORMATION, INCLUDING ESTIMATED OLIANTITIES OF WORK SHOWN ON THESE	DESIGNER/DRAFTER:  NAR	CONNECTICAL STATE OF THE CONNECTICAL STATE OF	SIGNATURE/ BLOCK:	PROJECT TITLE:	TOWN: OCCUM	PROJECT NO. 103-247
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REV. DATE REVISION DESCRIPTION SHEET NO. Plotted Date: 8/12/2015	NOT TO SCALE	Filename:\FD_MSH_CIV_0103_0247_CT003.dgn	Amy M.D.	FACILITY	MOTOR FUEL ISLAND DETAILS	SHEET NO. <b>04.15</b>